
# BOATING ACCESS SITE DEVELOPMENT

FOR

# CITY OF EAST JORDAN

CHARLEVOIX COUNTY, MICHIGAN

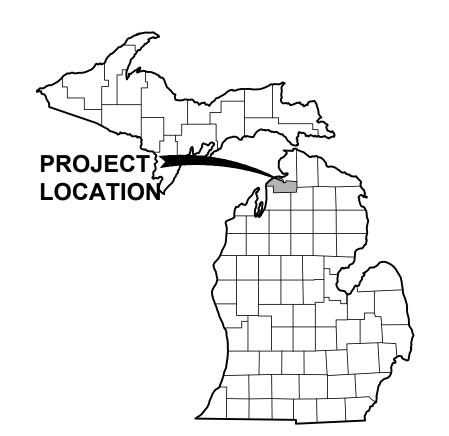

**VICINITY MAP** 

## **OWNER**

CITY OF EAST JORDAN 201 MAIN ST. EAST JORDAN, MI 49727 TOM CANNON, CITY ADMINISTRATOR

## **ENGINEER**

GOSLING CZUBAK ENGINEERING SCIENCES, INC.

www.goslingczubak.com info@goslingczubak.com

#### **UTILITY CONTACTS**

NAME OF OWNER TYPE OF UTILITY GAS DTE ENERGY

Mr. Matthow Logan 1250 Michcon Lane, SW P.O. Box 279 Kalkaska, MI 49646 231.492.7479

CONSUMER'S ENERGY ELECTRIC Ms. Megan Cogswell

1125 W. Green St. Hastings, MI 49058 269-948-3503

CHARTER COMMUNICATIONS CABLE TV

Mr. Steve Thinel 408 W. 4th St. Gaylord, MI 49735 231.932.8117

Mr. Ron Ouellette

AT&T

**TELEPHONE** 

1151 US 31 N Petoskey, MI 49770 231.349.8013

SEWER & WATER

Mr. Troy Thomas 201 E. Main St. East Jordan, Mi 49727 231.536.3381


CITY OF EAST JORDAN

#### **PERMITS**

MDEQ/ACOE JOINT PERMIT - INDIVIDUAL PERMIT SUBMISSION # HND-ZYQA-7BAN2 STATUS: PENDING FINAL APPROVAL

CHARLEVOIX CO. SOIL EROSION AND SEDIMENT CONTROL PERMIT #.T.B.D. STATUS: APPLICATION YET TO BE SUBMITTED



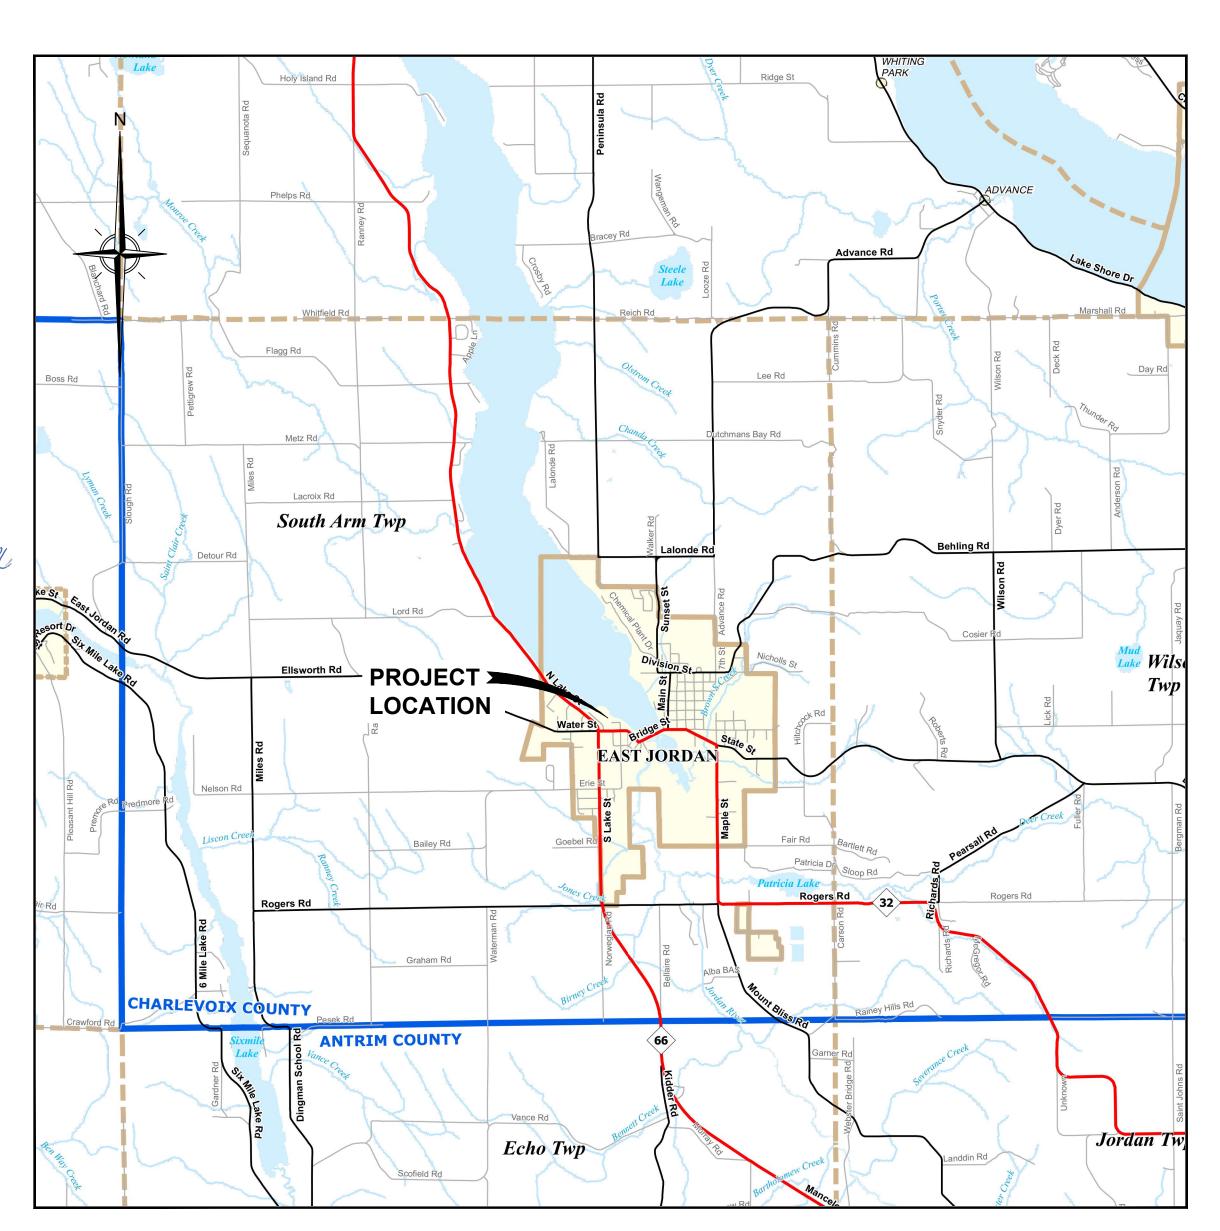


**LOCATION MAP** NOT TO SCALE

## **SHEET INDEX**

- S1 EXISTING CONDITIONS & REMOVALS PLAN
- S2 OVERALL PROPOSED LAYOUT
- S3 PARKING LOT GRADING & LAYOUT
- S4 DREDGE DISPOSAL DETAILS
- S5 BOAT LAUNCH AND DREDGE DETAILS
- S6 CONSTRUCTION DETAILS
- S7 CONSTRUCTION DETAILS
- S8 SKID PIER DETAILS
- L1 LANDSCAPE AND SIGNAGE PLAN L2 LANDSCAPE AND SIGNAGE DETAILS

Project No. 2017510001.0

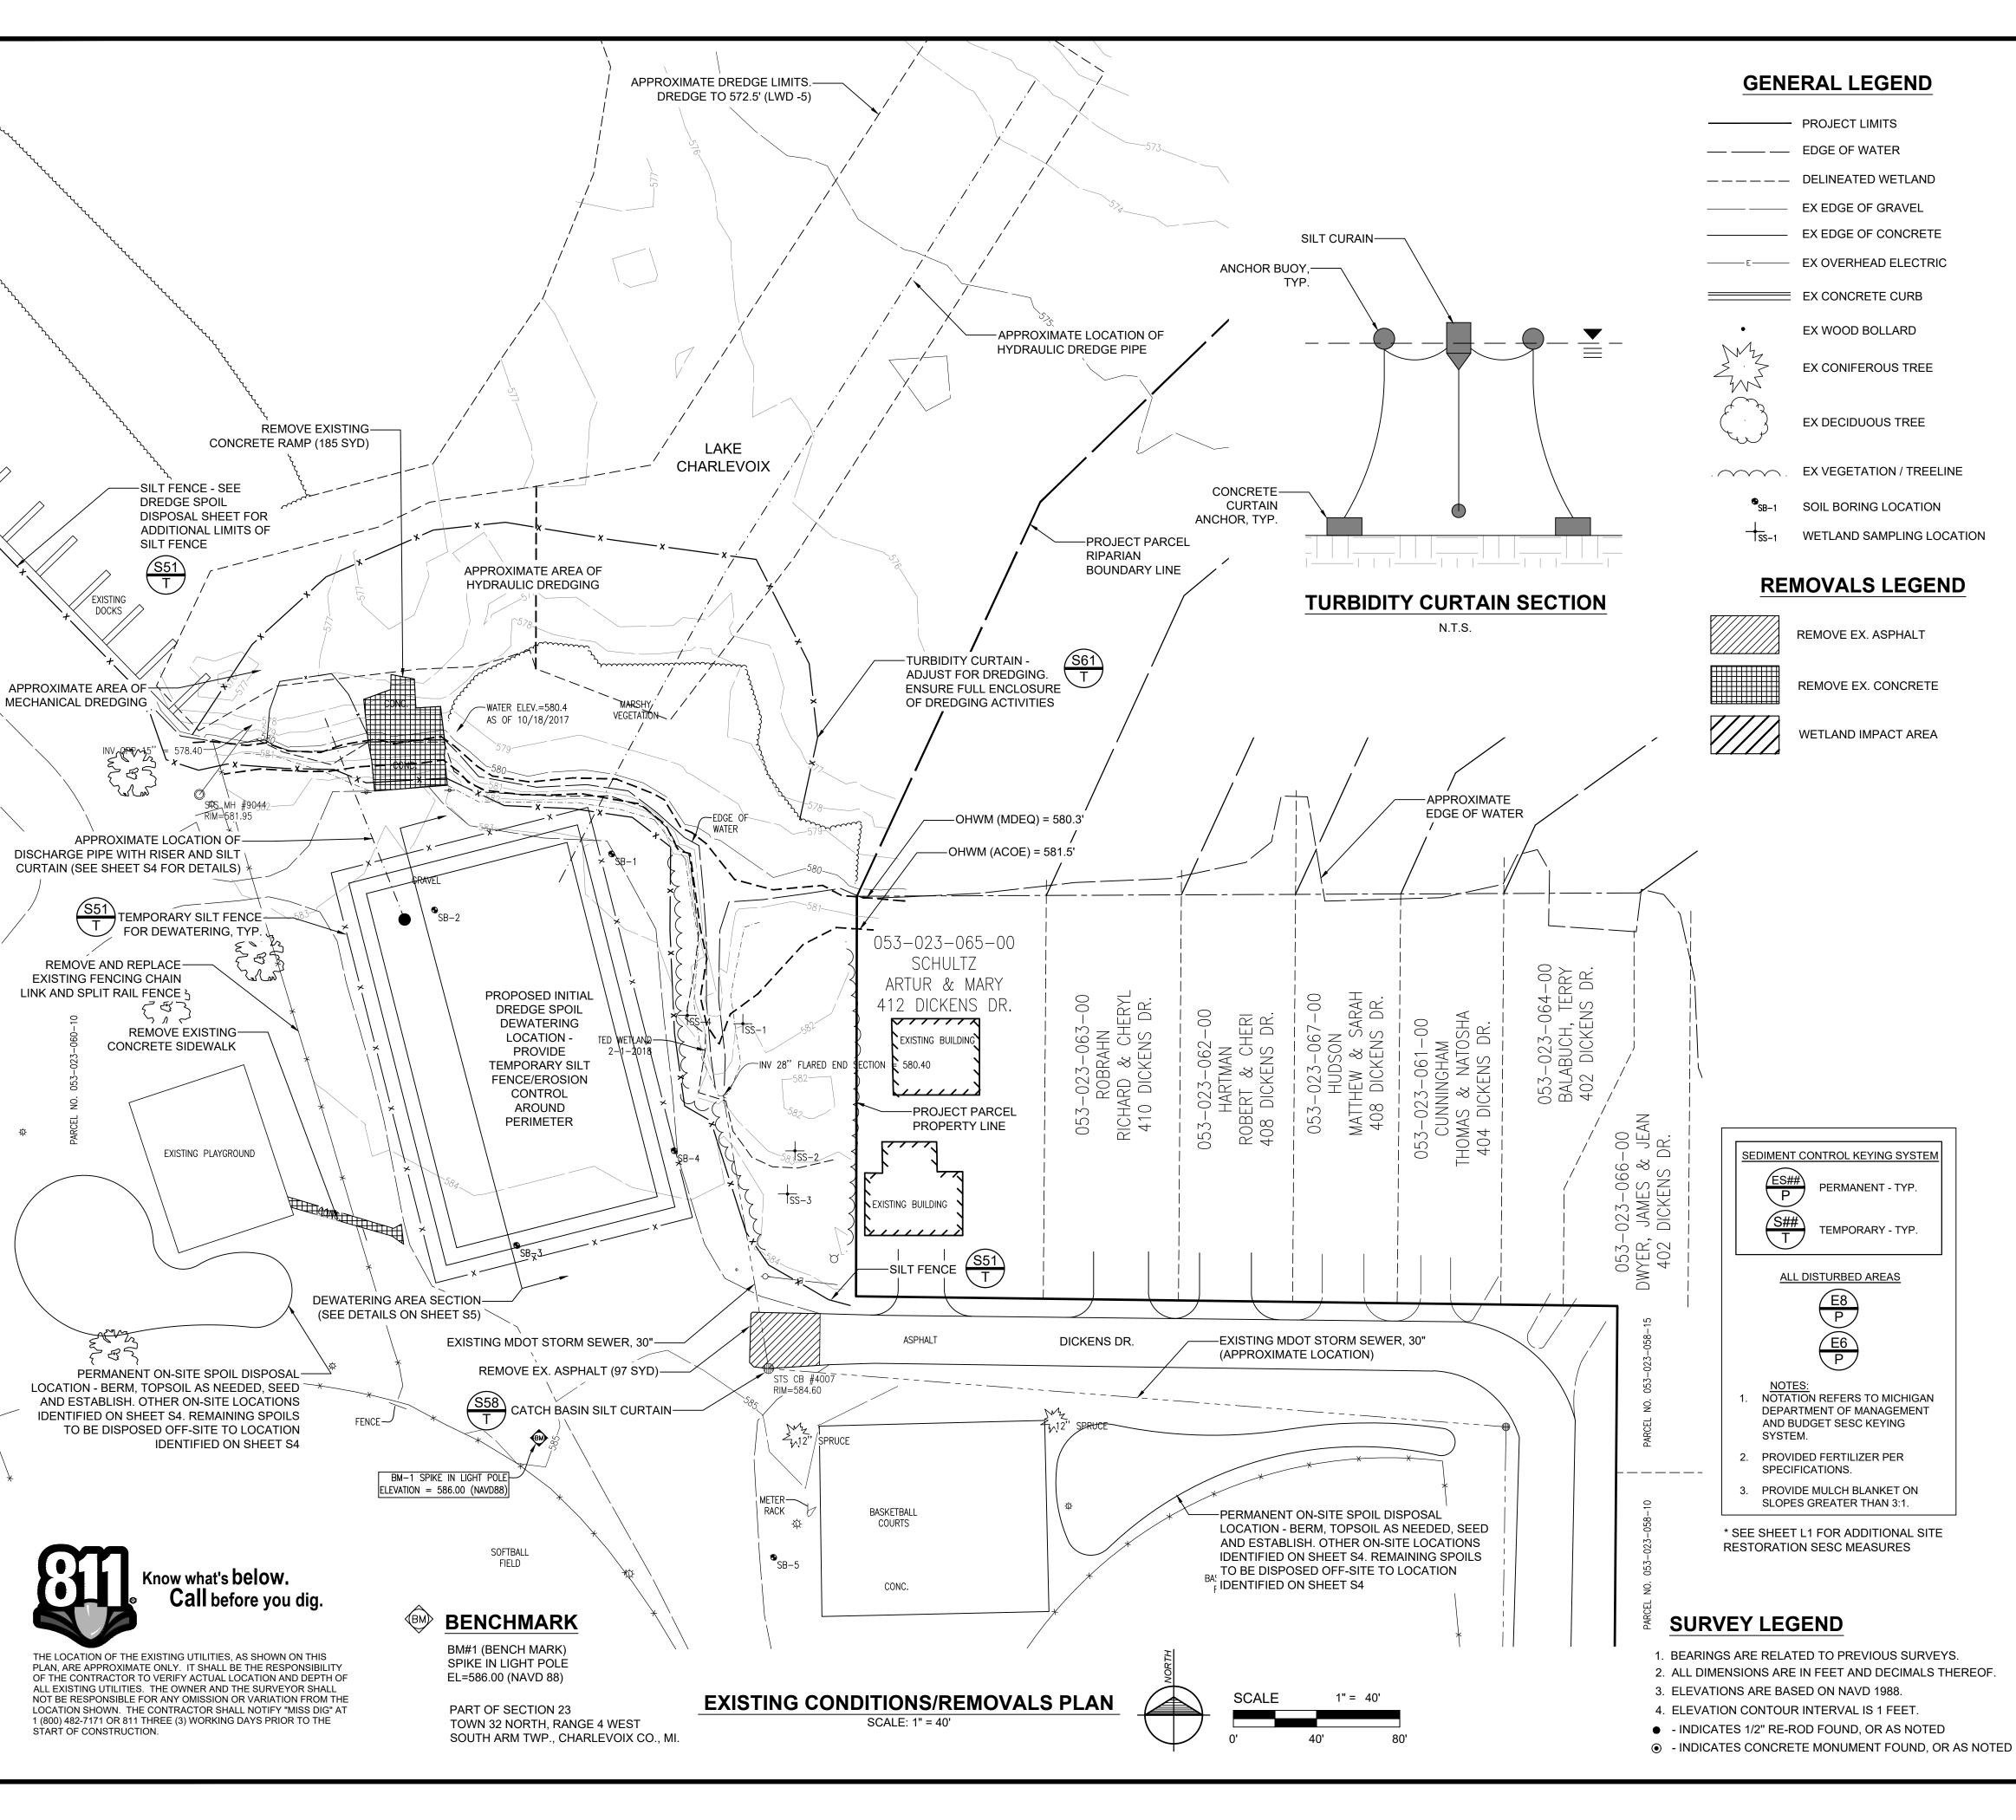

## SOIL EROSION AND SEDIMENTATION CONTROL NOTES

- 1. NOTATION REFERS TO MICHIGAN DEPARTMENT OF MANAGEMENT AND BUDGET SESC KEYING SYSTEM.
- 2. SOIL EROSION AND SEDIMENTATION CONTROL SHALL PROTECT AGAINST LOSS OF SOIL BY THE ACTION OF WATER, ICE AND GRAVITY OF WIND.
- 3. ALL EARTH CHANGES SHALL BE DESIGNED, CONSTRUCTED, AND MAINTAINED IN SUCH A MANNER AS TO MINIMIZE THE EXTENT AND DURATION OF EARTH DISRUPTION.
- 4. THE CONTRACTOR SHALL LOCATE STOCKPILES IN AREAS AS SHOWN ON THE PLANS OR WITHIN THE LIMITS OF THE DISTURBED AREA(S) AS WORK PROGRESSES.
- 5. VEGETATIVE STABILIZATION OR OTHER SOIL EROSION CONTROL MEASURES SHALL BE INSTALLED AND MAINTAINED THROUGHOUT THE DEVELOPMENT PROCESS.
- EARTH CHANGES ASSOCIATED WITH LARGE DEVELOPMENTS SHALL BE STAGED TO KEEP EXPOSED AREAS OF THE SOIL AS SMALL AS PRACTICABLE. CRITICAL AREAS EXPOSED DURING CONSTRUCTION SHALL BE PROTECTED WITH TEMPORARY VEGETATION, MULCHING, FILTER FENCES, OR OTHER METHODS OF STABILIZATION.
- 7. STORMWATER RUNOFF CONTROL AND SOIL EROSION CONTROL MEASURES SHALL BE INSTALLED BEFORE GRADING, FILLING, OR REMOVAL OF VEGETATIVE COVER IS INITIATED..
- 8. WHEN IT IS NOT POSSIBLE TO PERMANENTLY STABILIZE A DISTURBED AREA AFTER AN EARTH CHANGE HAS BEEN COMPLETED OR WHEN SIGNIFICANT EARTH CHANGE ACTIVITY CEASES, TEMPORARY SOIL EROSION CONTROL MEASURES SHALL BE INSTALLED AND MAINTAINED.
- PERMANENT EROSION CONTROL MEASURE FOR ALL SLOPES, CHANNELS DITCHES, OR ANY DISTURBED LAND AREA SHALL BE COMPLETED WITHIN FIFTEEN CALENDAR DAYS AFTER FINAL GRADING OR THE FINAL EARTH CHANGE HAS BEEN COMPLETED. ALL TEMPORARY SOIL EROSION CONTROL MEASURES SHALL BE MAINTAINED UNTIL PERMANENT SOIL EROSION CONTROL MEASURES ARE ESTABLISHED.
- 10. SOIL EROSION CONTROL MEASURES SHALL BE MAINTAINED THROUGHOUT THE DURATION OF THE EARTH CHANGE, INCLUDING THE LATER STAGES OF DEVELOPMENT. MAINTENANCE ACTIVITIES INCLUDE, BUT ARE NOT LIMITED TO REMOVAL OF ACCUMULATED SEDIMENT, STRUCTURAL REPAIRS, RE-SEEDING, REPLACEMENT OF VEGETATIVE COVER, AND LAWN MOWING.
- 11. ALL TEMPORARY EROSION CONTROL FACILITIES SHOULD BE REMOVED BY THE CONTRACTOR AT THE COMPLETION OF CONSTRUCTION UNLESS ORDERED BY THE ENGINEER TO BE LEFT IN PLACE. CARE SHOULD BE TAKEN DURING REMOVAL TO MINIMIZE SILTATION IN NEARBY DRAINAGE COURSES.
- 12. PERIMETER SILT FENCE TO BE INSTALLED PRIOR TO DEMOLITION. INLET STORM STRUCTURE SEDIMENTATION CONTROL MEASURES TO BE INSTALLED AS STRUCTURES ARE INSTALLED.

### **REMOVALS NOTES**

- REMOVE ALL TREES INCLUDING CUTTING STUMP AND GRINDING 12" MIN BELOW FINISHED GRADE AS INDICATED ON PLANS.
- 2. PROTECT ALL TREES AND SHRUBS NOT SCHEDULED FOR REMOVAL AS INDICATED ON PLANS. DO NOT OPERATE EQUIPMENT, STORE, STOCKPILE, OR PARK WITHIN DRIPLINE (DIAMETER OF CANOPY) OF TREES TO MINIMIZE SOIL COMPACTION AND PROTECT ROOT ZONE OF TREE. PROVIDE SILT FENCE BARRIER AROUND DRIP LINE OF TREE WHERE INDICATED ON PLANS. HOLD NECESSARY DISTURBANCE TO A MINIMUM.
- S. CONTRACTOR TO PROVIDE FINAL LOCATION OF STOCKPILE, MATERIAL AND MACHINERY STAGING AREAS AND GET APPROVAL FROM LANDSCAPE ARCHITECT AND OWNER PRIOR TO COMMENCING WORK ON-SITE. CONTRACTOR WILL ENSURE ADEQUATE EROSION CONTROL MEASURES NOT LIMITED TO SILT FENCE INSTALLATION.
- 4. DO NOT OPERATE HEAVY MACHINERY BELOW SHORELINE UNLESS APPROVED BY THE PROFESSIONAL
- THE CONTRACTOR WILL BE HELD RESPONSIBLE FOR DAMAGE TO ITEMS NOT SCHEDULED FOR REMOVAL.
- . CONTRACTOR TO USE DISCRETION FOR RE-USE OF AGGREGATE BASE MATERIAL. IF CONTRACTOR DECIDES TO REUSE EXCAVATED BASE AGGREGATE IN PLACE OF NEW BASE MATERIAL, INSTALLATION WILL BE COMPLETED IN ACCORDANCE WITH PLANS, DETAILS, AND SPECIFICATIONS. BASE MATERIAL WILL MEET OR EXCEED ALL TESTING REQUIREMENTS AS INDICATED IN SECTION 01410 OF THE CONSTRUCTION SPECIFICATIONS.
- 7. TOP SOIL AND RESEED ALL AREAS DISTURBED BY CONSTRUCTION ACTIVITIES. REFER TO PLANS FOR SPECIAL AREAS TO RECEIVE NATIVE SEED MIXES OR NO-MOW FESCUES.
- REMOVAL ITEMS SHOWN ARE BASED ON BEST AVAILABLE INFORMATION AND ARE SHOWN SCHEMATICALLY. THE CONTRACTOR SHALL WALK THE SITE PRIOR TO BID TO BECOME FAMILIAR WITH THE EXTENT OF REMOVAL ITEMS. THE CONTRACTOR IS RESPONSIBLE FOR ALL REMOVALS NECESSARY TO COMPLETE CONSTRUCTION. QUESTIONS REGARDING ITEMS TO BE REMOVED SHALL BE DIRECTED TO THE LANDSCAPE ARCHITECT.
- 9. PRIOR TO CONSTRUCTION, REMOVE AND SALVAGE ALL ITEMS AS INDICATED ON PLANS.
- 10. STRIP AND STOCKPILE TOPSOIL IN A LOCATION APPROVED BY THE ENGINEER AND PROVIDE ALL NECESSARY S.E.S.C. MEASURES TO ELIMINATE EROSION. DO NOT STRIP TOPSOIL FROM AREAS TO BE RESTORED WITH NATIVE SEED EXCEPT IF DISTURBED BY EARTHWORK OR FOR NEW RETENTION AREAS AS INDICATED ON THE PLANS.
- 11. COORDINATE ELECTRICAL SERVICE, DISTRIBUTION, REMOVALS WITH LOCAL UTILITY COMPANY

Gosling Czuba


engineering sciences, inc.

1280 Business Park Dr.
Traverse City, Michigar

Traverse City, Michiga 231-946-9191 phone info@goslingczubak.com www.goslingczubak.com

CIVIL ENGINEERING
SURVEYING
ENVIRONMENTAL SERVICES
GEOTECHNICAL
CONSTRUCTION SERVICES

LANDSCAPE ARCHITECTURE

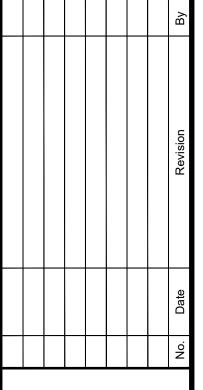

EXISTING CONDITIONS & REMOVALS PLAN AST JORDAN BOAT LAUNCH IMPROVEMEN EAST JORDAN

Date Issued:
Date Surveyed:
Designed By:
Drawn By:
Checked By:
Scale:

Original sheet size is 22x34


Location:
PART OF SECTION 23
T23N-R7W


T23N-R7W SOUTH ARM TWP CHARLEVOIX COUNTY, MI

03-15-2018

oject Number: 2017510001.01


**S1** 

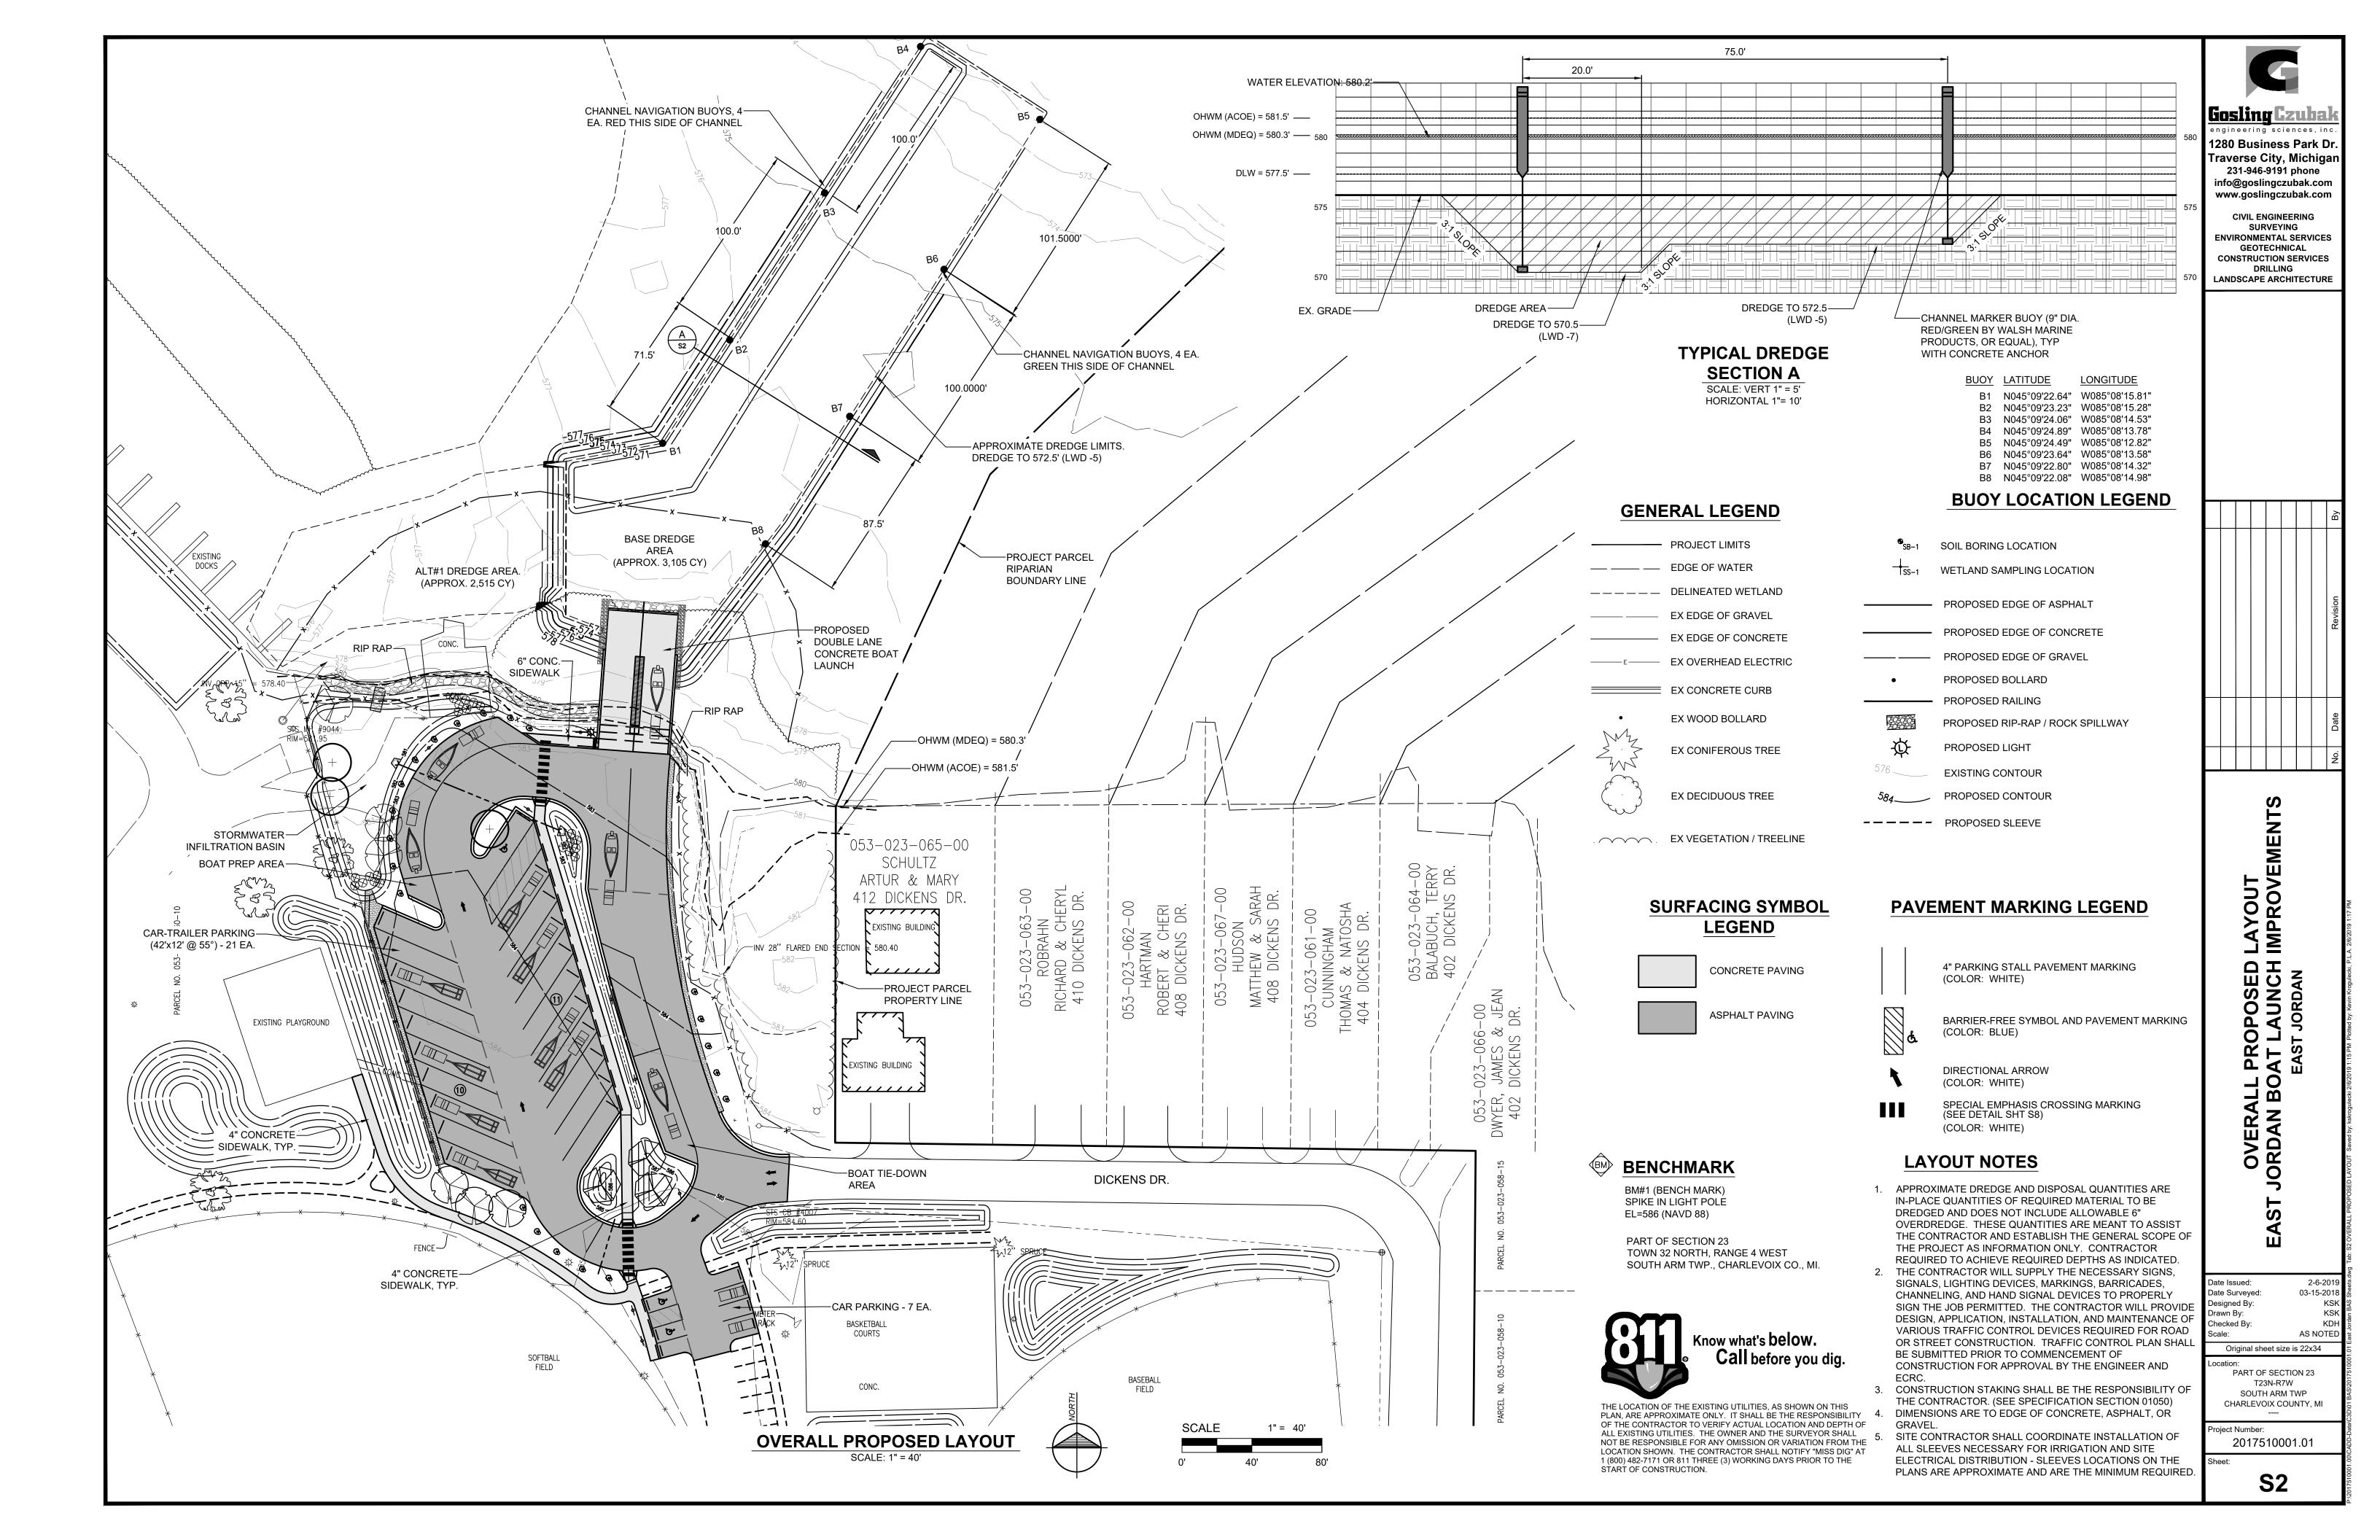

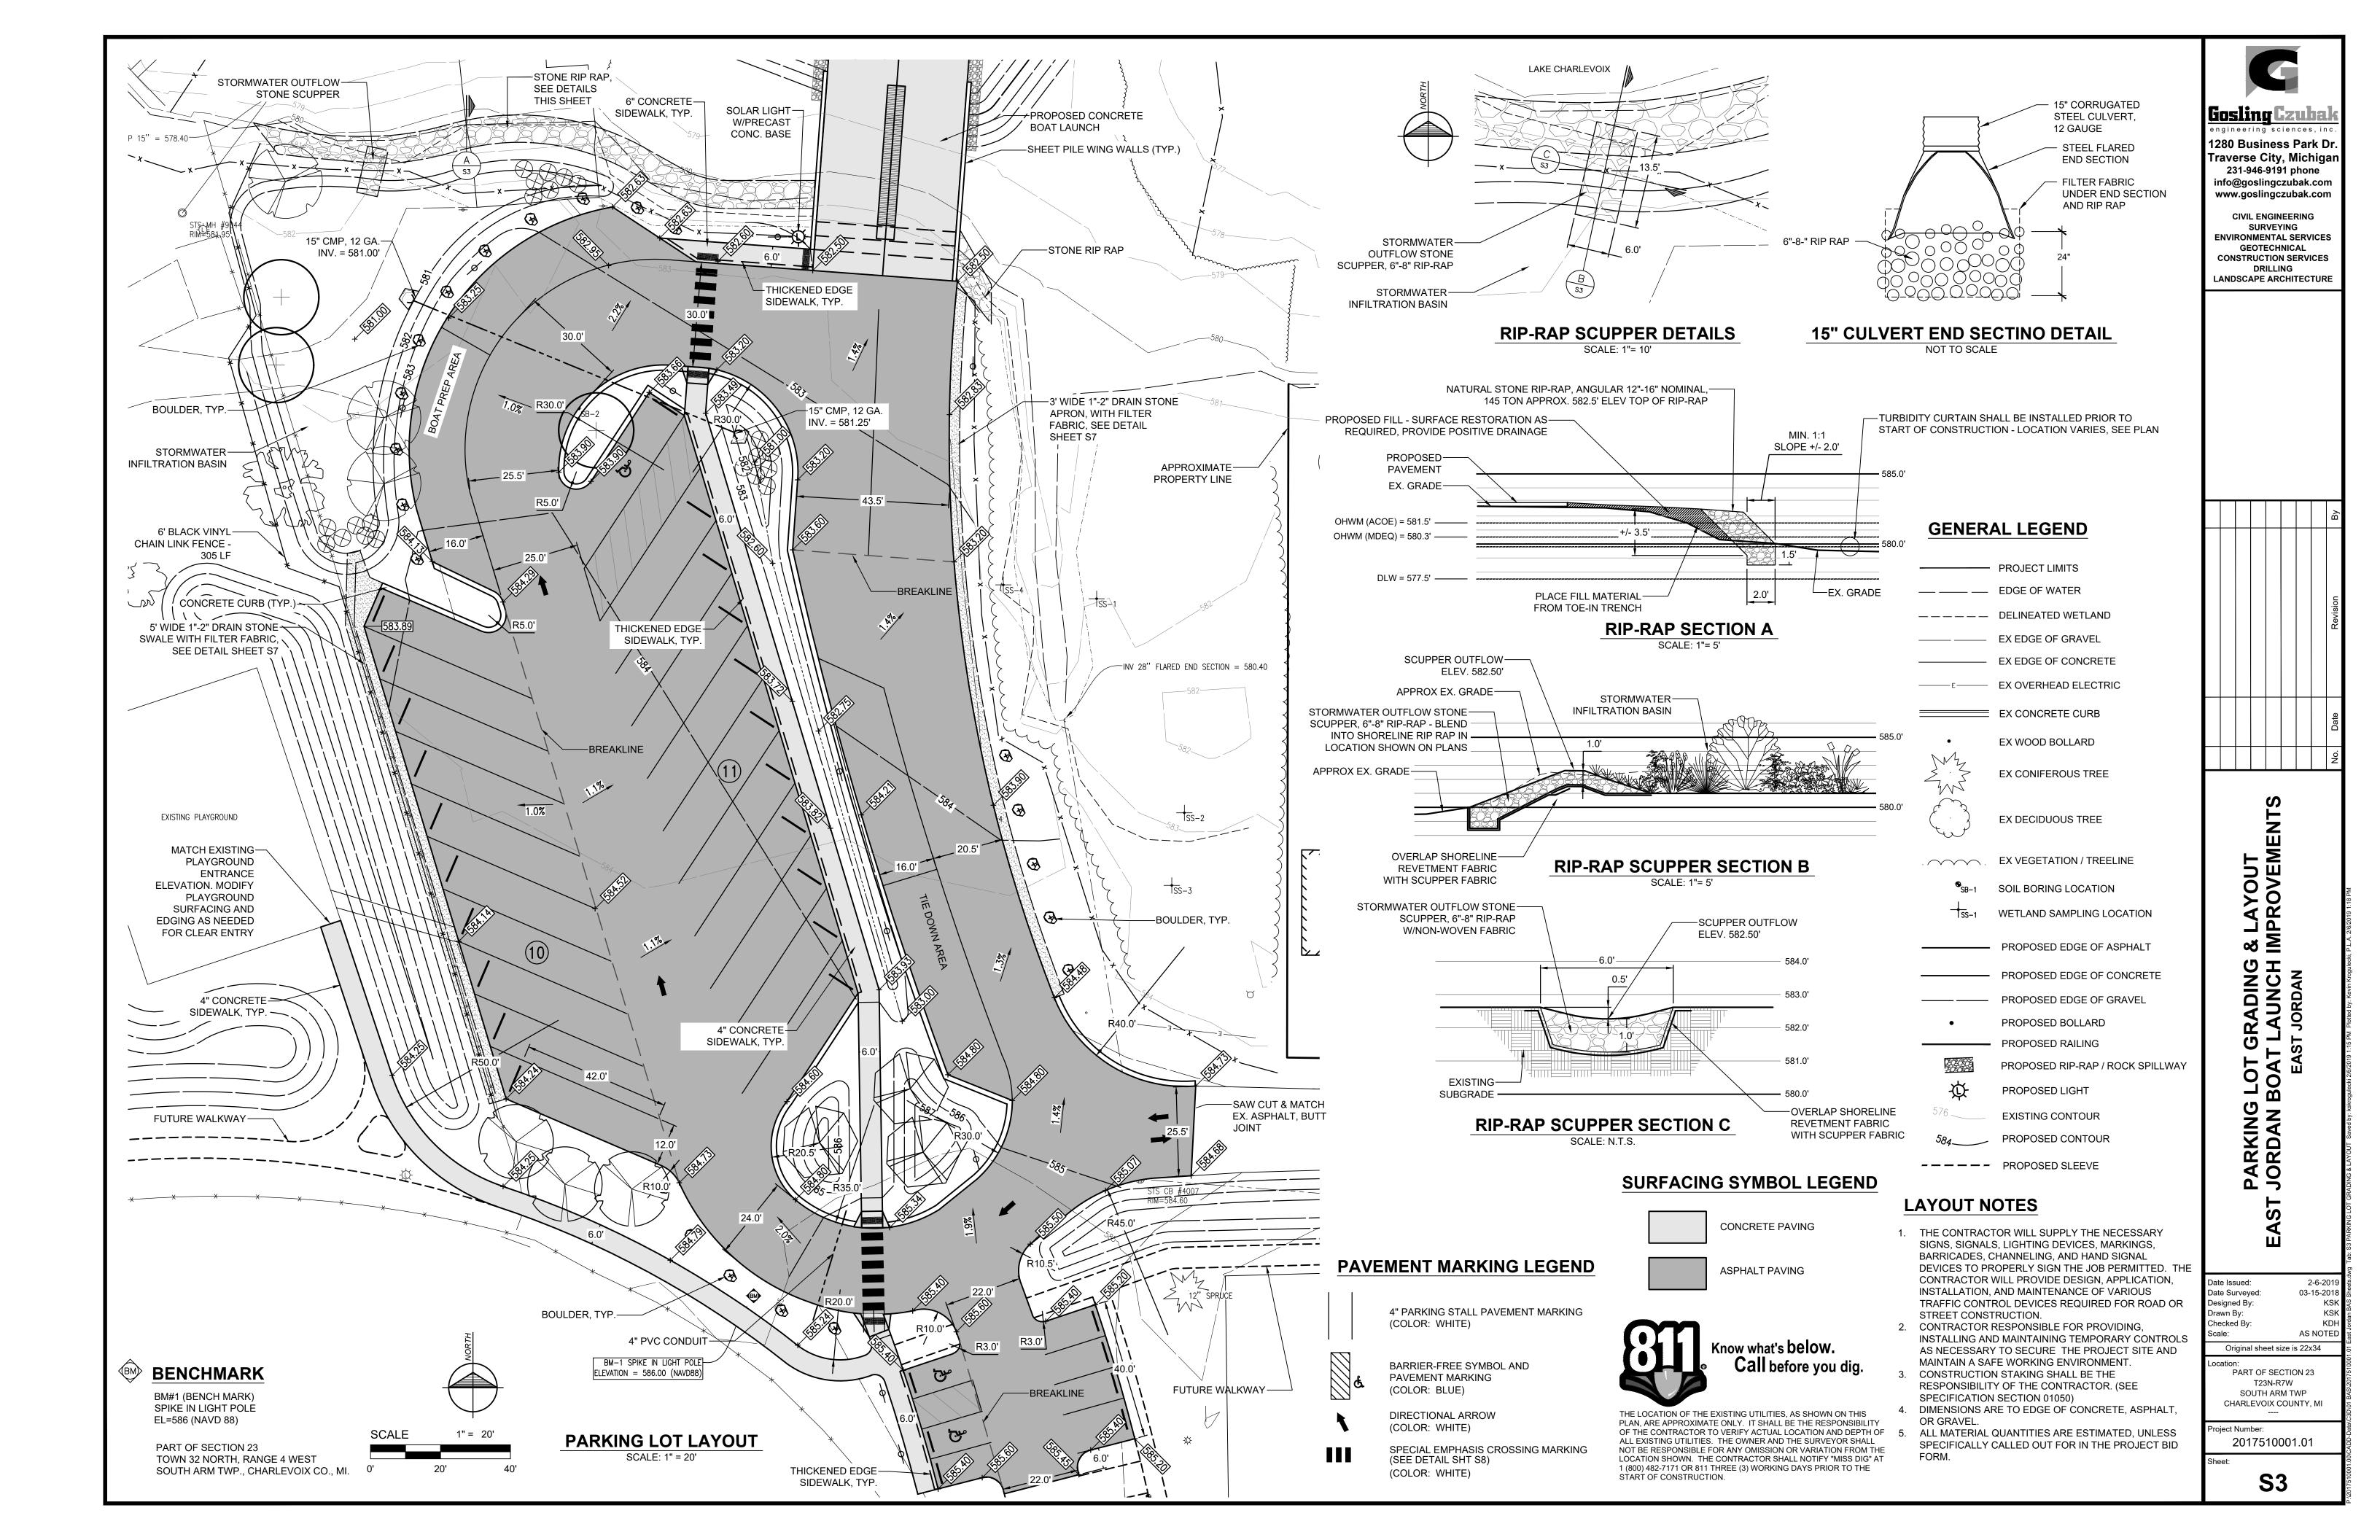

## BERM 9 SILT FENCE, ENTIRE LENGTH OF SHORELINE WITHIN INFLUENCE OF EARTHWORK DOCKS BERM 4 CAMPGROUND SILT FENCE, ENTIRE LENGTH OF DITCH BERM 2 WITHIN INFLUENCE OF BERM 7 BERM 5 BERM 3 × \*\*\*\* M-32 ADDITIONAL LOCATION FOR EXCESS GRAVEL FROM NEW PARKING LOT CONSTRUCITON. PLACE GRADE AND ROLL TO ALLOW FOR POSITIVE DRAINAGE AND AN ACCEPTABLE GRAVEL PARKING SERVICE. QUANTITY AND LOCATION OF FINAL GRAVEL PLACEMENT TO BE DETERMINED BY THE OWNER AT TIME OF CONSTRUCITON

#### **DREDGE SPOIL DISPOSAL AREAS** SCALE: 1" = 80'

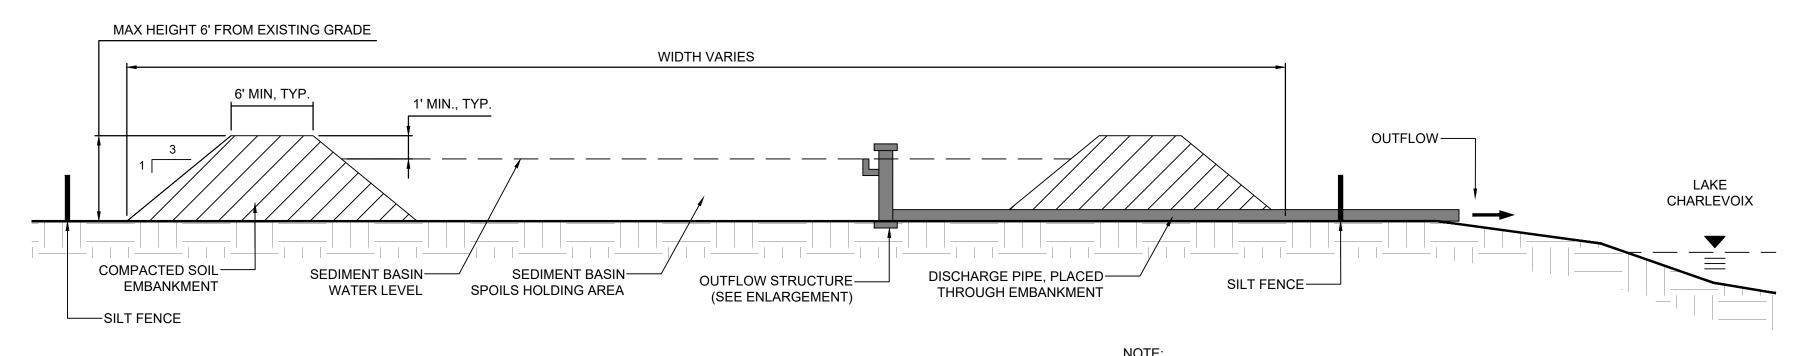


### DREDGE SPOIL DEWATERING AREA, TYP. DETAIL

1. MAXIMUM SLOPE OF ALL EMBANKMENT SIDE SLOPES IS 1v:2h 2. SILT FENCE TO BE INSTALLED AND MAINTAINED AROUND THE

PERIMETER OF DEWATERING AREA

3. OUTFLOW STRUCTURE IS SCHEMATIC AND PROVIDED TO SHOW INTENT. DESIGN MAY VARY BASED UPON APPROVED CONTRACTOR MEANS AND METHODS.

#### **OFF-SITE DREDGE SPOIL DISPOSAL LOCATION**

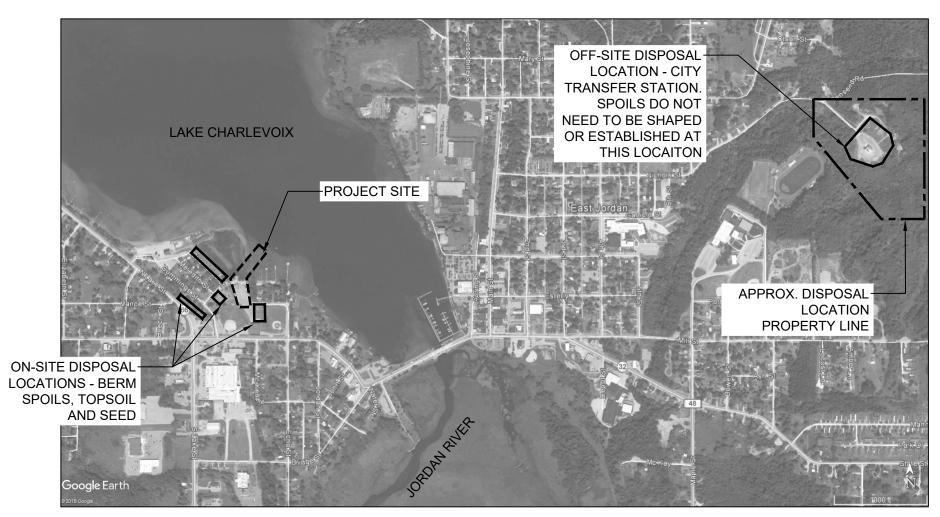

\* OFF-SITE DISPOSAL LOCATION PROPERTY (CITY TRANSFER FACILITY) OWNED BY THE CITY OF EAST JORDAN - PARCEL NO.: 053-024-000-50; ADDRESS: 700 NICHOLS ST, EAST JORDAN, MI

-DISCHARGE

PIPE

## **Dredging Notes**

- 1. APPROXIMATE DREDGE QUANTITIES ARE AS FOLLOWS: - BASE BID = 3,150 CY ON-SITE 860 CY OFF-SITE
  - ALT #1 = 2,560 CY OFF-SITE
- 2. APPROXIMATE DREDGE AND DISPOSAL QUANTITIES ARE IN-PLACE QUANTITIES OF REQUIRED MATERIAL TO BE DREDGED AND DOES NOT INCLUDE ALLOWABLE 6" OVERDREDGE. THESE QUANTITIES ARE MEANT TO ASSIST THE CONTRACTOR AND ESTABLISH THE GENERAL SCOPE OF THE PROJECT AS INFORMATION ONLY. CONTRACTOR REQUIRED TO ACHIEVE REQUIRED DEPTHS AS INDICATED.
- 3. CONTRACTOR RESPONSIBLE TO PERFORM AND PROVIDE POST-DREDGE BATHYMETRIC SURVEY INFORMATION FOR REVIEW AND APPROVAL PRIOR TO COMPLETION OF DREDGING ACTIVITIES. FINAL DREDGING APPROVAL WILL NOT BE GIVEN UNTIL PROJECT DEPTHS ARE MET.
- 4. ON-SITE DREDGE SPOIL DISPOSAL INFORMATION:
  - BERM 1: 213 CY APPROX., 0'-3' HIGH, 1:3 SLOPE - BERM 2: 600 CY APPROX., 0'-6' HIGH, 1:3 SLOPE
  - BERM 3: 397 CY APPROX., 0'-6' HIGH, 1:3 SLOPE - BERM 4: 800 CY APPROX., 0'-1' HIGH, 1:3 SLOPE
  - BERM 5: 117 CY APPROX., 0'-2' HIGH, 1:3 SLOPE - BERM 6: 340 CY APPROX., 0'-5' HIGH, 1:3 SLOPE
  - BERM 7: 250 CY APPROX., 0'-3' HIGH, 1:3 SLOPE
- BERM 8: 176 CY APPROX., 0'-4' HIGH, 1:3 SLOPE - BERM 9: 260 CY APPROX., 0'-4' HIGH, 1:3 SLOPE

TRASH-

ADJUSTABLE-

STRUCTURE

OUTFLOW

- 5. LOCATION AND QUANTITY OF DREDGE SPOIL PLACEMENT ON-SITE MAY VARY BASED ON DIRECTION BY THE OWNER.
- 5. USE EXISTING STRIPPED TOPSOIL TO RESTORE AND ESTABLISH BERM AND DREDGE SPOIL PLACEMENT AREAS ON-SITE AND WITHIN THE PARK. SUPPLEMENT WITH NEW TOPSOIL AS NEEDED TO ACHIEVE FULL ESTABLISHMENT OF ALL DISTURBED AREAS.
- 6. OFF-SITE DISPOSAL LOCATION DOES NOT REQUIRE BERMING, SHAPING, TOPSOIL

**OUTFLOW STRUCTURE ENLARGEMENT** 

## **GENERAL LEGEND**

PROJECT LIMITS

—— —— EDGE OF WATER ————— DELINEATED WETLAND

EX EDGE OF GRAVEL

— EX EDGE OF CONCRETE

EX OVERHEAD ELECTRIC

EX CONCRETE CURB

EX WOOD BOLLARD

EX CONIFEROUS TREE

EX DECIDUOUS TREE

EX VEGETATION / TREELINE

SOIL BORING LOCATION

— PROPOSED EDGE OF ASPHALT

WETLAND SAMPLING LOCATION

PROPOSED EDGE OF CONCRETE

PROPOSED EDGE OF GRAVEL

PROPOSED BOLLARD PROPOSED RAILING


PROPOSED RIP-RAP / ROCK SPILLWAY


**EXISTING CONTOUR** 

PROPOSED LIGHT

PROPOSED CONTOUR

---- PROPOSED SLEEVE

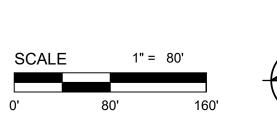


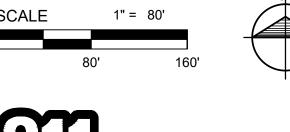



Call before you dig

THE LOCATION OF THE EXISTING UTILITIES, AS SHOWN ON THIS PLAN, ARE APPROXIMATE ONLY. IT SHALL BE THE RESPONSIBILITY OF THE CONTRACTOR TO VERIFY ACTUAL LOCATION AND DEPTH OF ALL EXISTING UTILITIES. THE OWNER AND THE SURVEYOR SHALL NOT BE RESPONSIBLE FOR ANY OMISSION OR VARIATION FROM THE LOCATION SHOWN. THE CONTRACTOR SHALL NOTIFY "MISS DIG" AT 1 (800) 482-7171 OR 811 THREE (3) WORKING DAYS PRIOR TO THE START OF CONSTRUCTION.

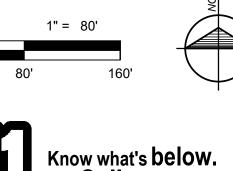

Original sheet size is 22x34 PART OF SECTION 23 T23N-R7W SOUTH ARM TWP CHARLEVOIX COUNTY, MI roject Number:

Date Issued:

Designed By:

Checked By:

Drawn By:

Date Surveyed:

03-15-2018

2017510001.01 **S4** 

DETAILS HIMPROVI

DISP()AT L/

ШΟ

 $\overline{\Omega}$   $\overline{\Omega}$ 

DRED(

Gosling Czubal

1280 Business Park Dr.

Traverse City, Michigar

231-946-9191 phone


info@goslingczubak.com


www.goslingczubak.com

**CIVIL ENGINEERING** 


SURVEYING **ENVIRONMENTAL SERVICES** GEOTECHNICAL CONSTRUCTION SERVICES

DRILLING LANDSCAPE ARCHITECTURE

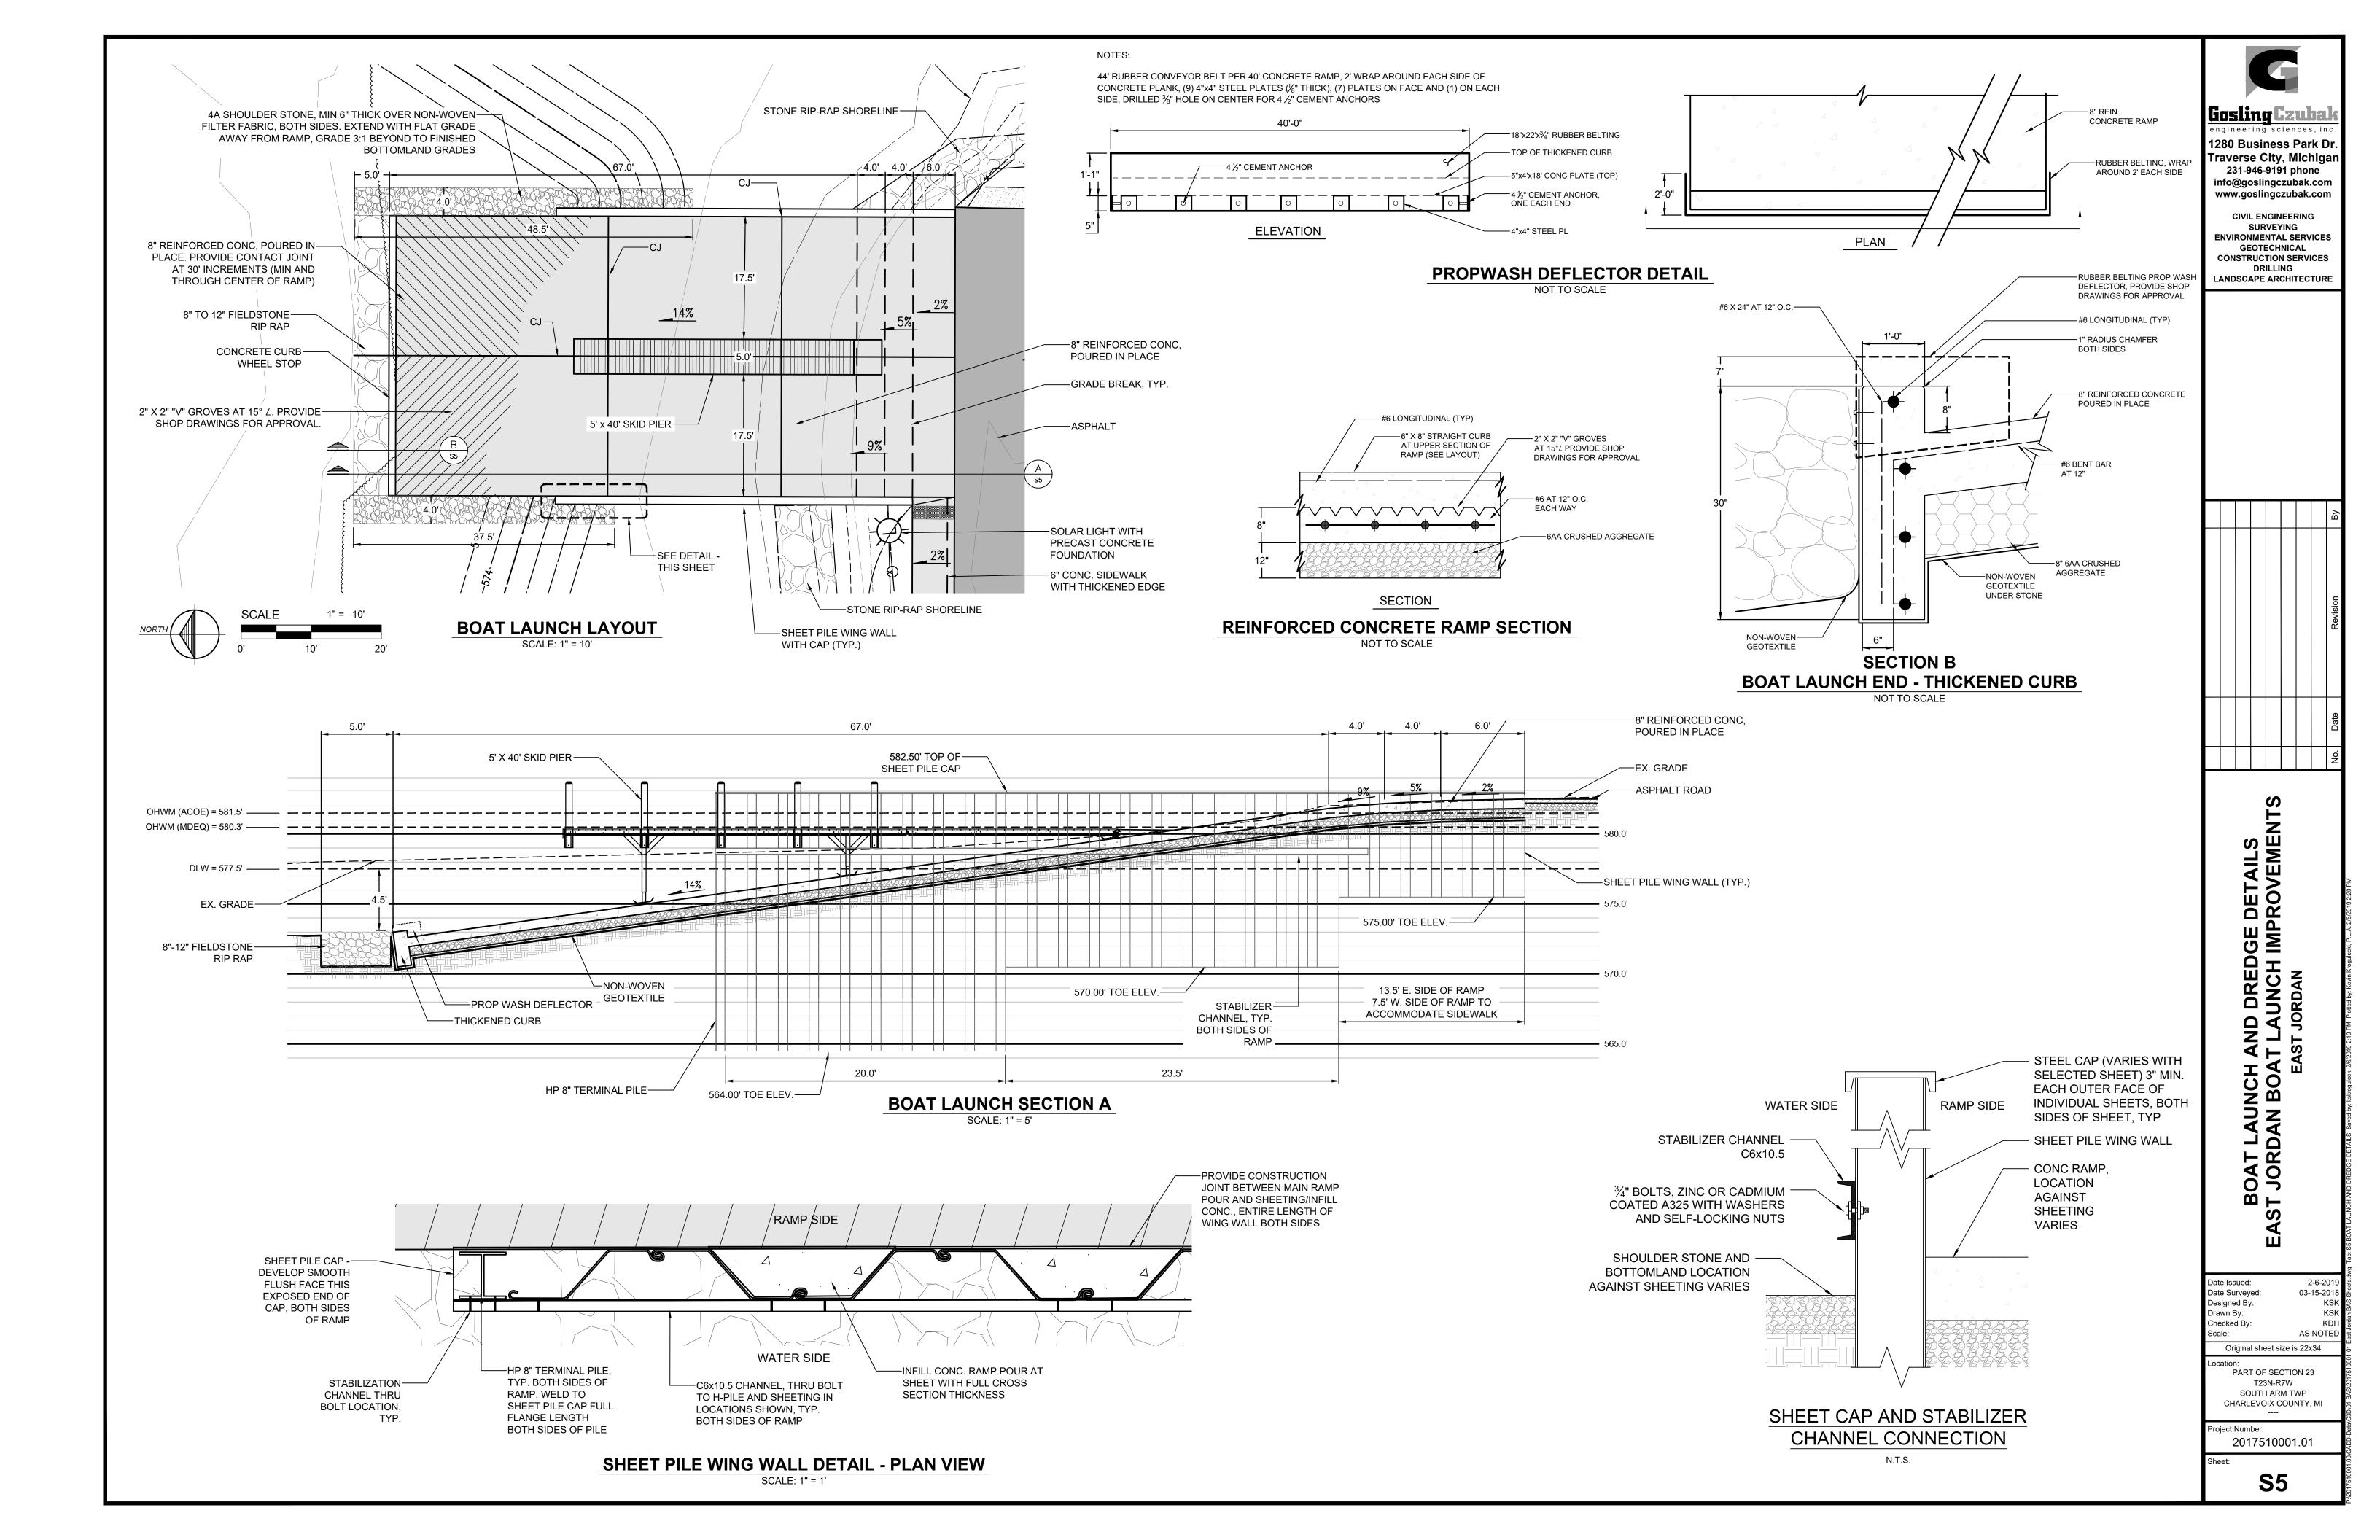


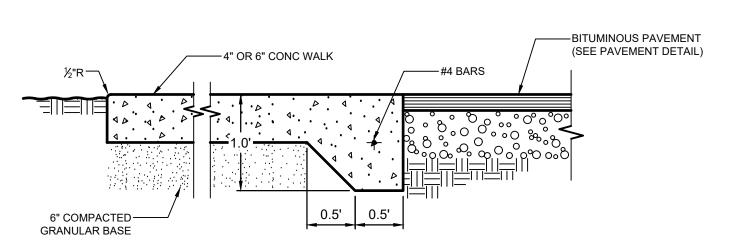


## FLUSH THICKENED EDGE SIDEWALK DETAIL

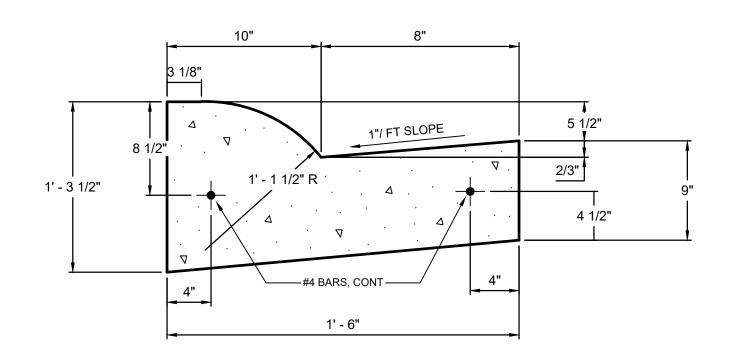


#### **MODIFIED MDOT "B2" CONCRETE CURB & GUTTER DETAIL** NOT TO SCALE

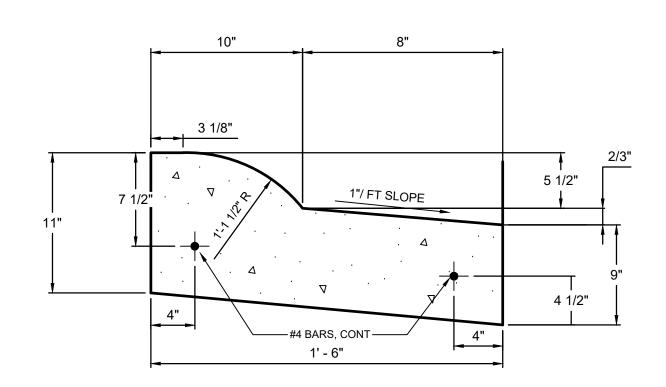


#### **MODIFIED MDOT "B2", INV. CONCRETE CURB & GUTTER DETAIL** NOT TO SCALE

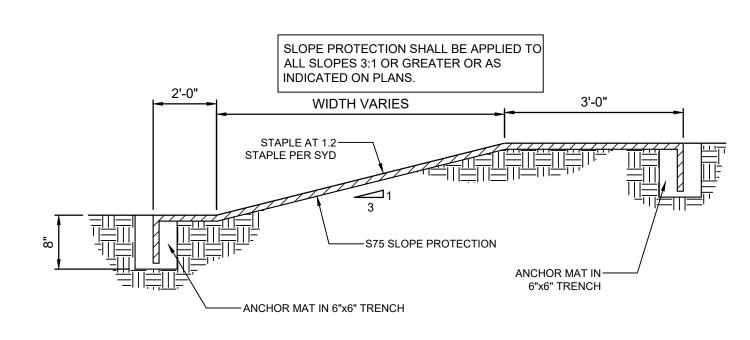


**MULCH BLANKET DETAIL** NOT TO SCALE

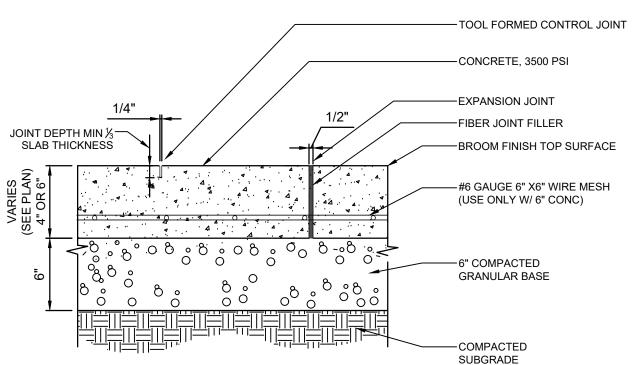

#### **CONCRETE PAVING & WALK SECTION DETAIL** NOT TO SCALE

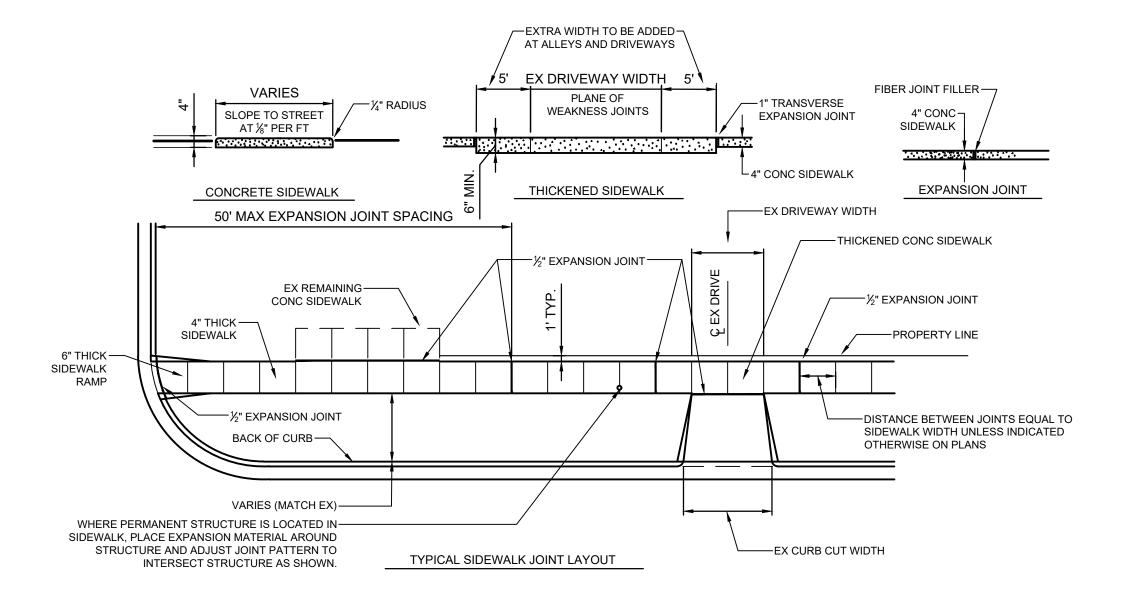


#### **TYPICAL CONCRETE SIDEWALK DETAILS** NOT TO SCALE

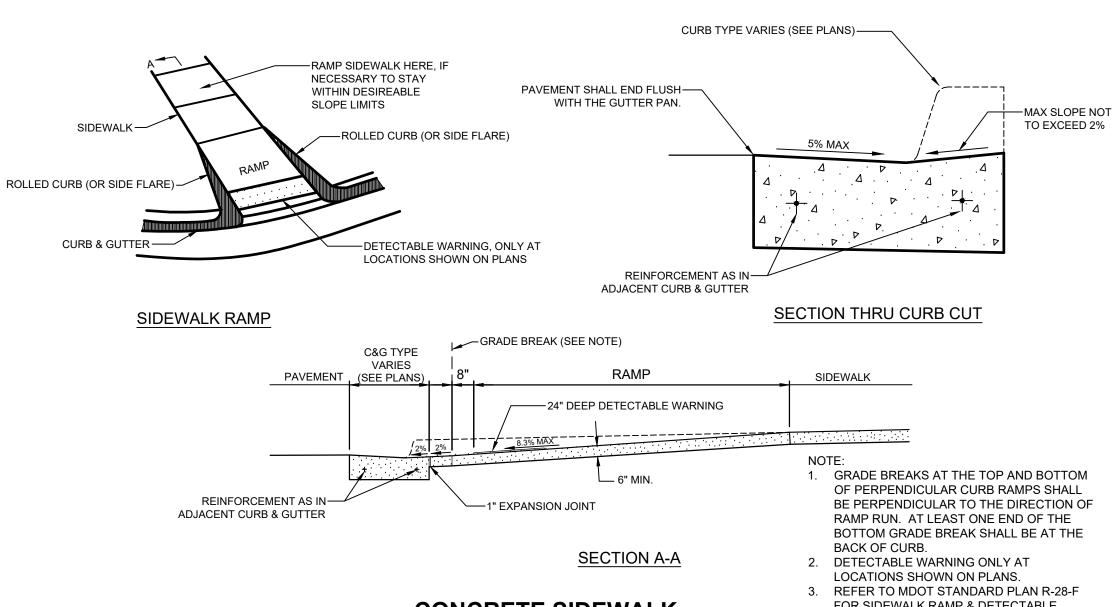


**RAMP DETAILS** 

NOT TO SCALE

FOR SIDEWALK RAMP & DETECTABLE **CONCRETE SIDEWALK** WARNING DETAILS.

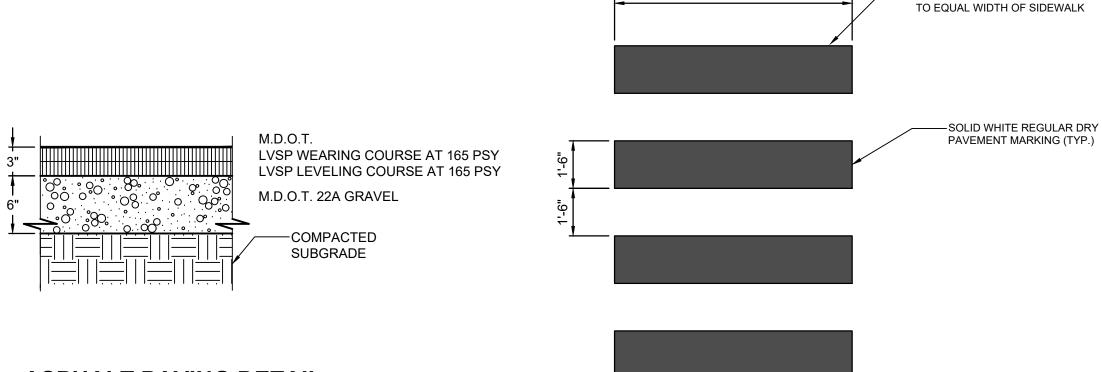


#### **ASPHALT PAVING DETAIL** NOT TO SCALE

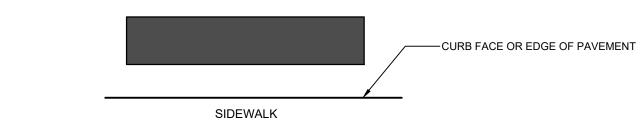

#### SPECIAL EMPHASIS CROSSWALK MARKING NOT TO SCALE


WIDTH VARIES (SEE PLAN)

-WIDTH OF CROSSWALK MARKING

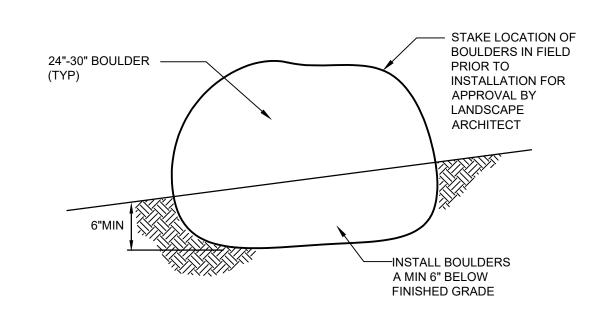


## **BOULDER INSTALLATION DETAIL**

NOT TO SCALE

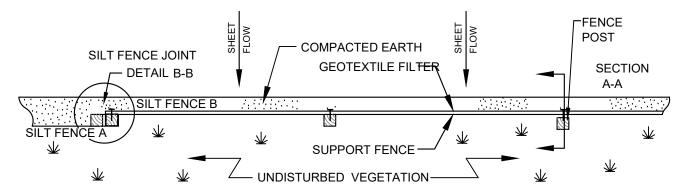

## PLAN VIEW

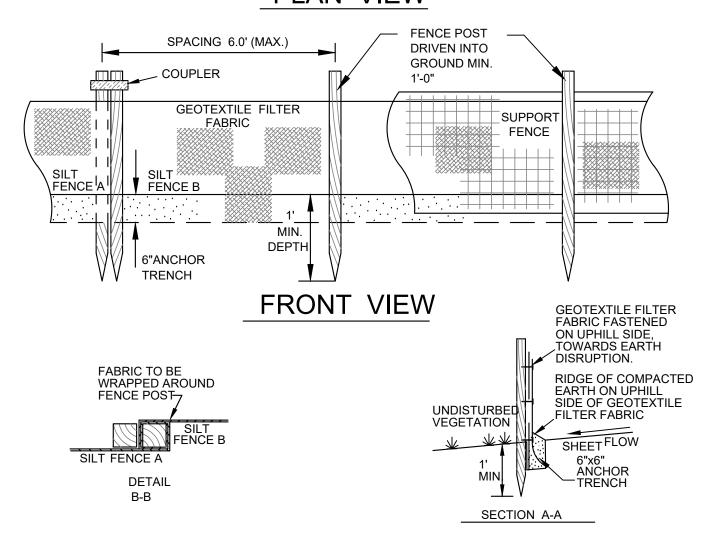

**SILT FENCE DETAIL** NOT TO SCALE

Liosling Czuba 1280 Business Park Dr. Traverse City, Michigar 231-946-9191 phone info@goslingczubak.com www.goslingczubak.com

CIVIL ENGINEERING

SURVEYING

**ENVIRONMENTAL SERVICES** 

GEOTECHNICAL

CONSTRUCTION SERVICES

DRILLING LANDSCAPE ARCHITECTURE


CONSTRUCTION DETAILS
JORDAN BOAT LAUNCH IMPROV
EAST JORDAN

Date Issued: Date Surveyed: 03-15-2018 Designed By: Orawn By: Checked By: AS NOTED Original sheet size is 22x34

PART OF SECTION 23 T23N-R7W SOUTH ARM TWP CHARLEVOIX COUNTY, MI

Project Number: 2017510001.01


**S6** 

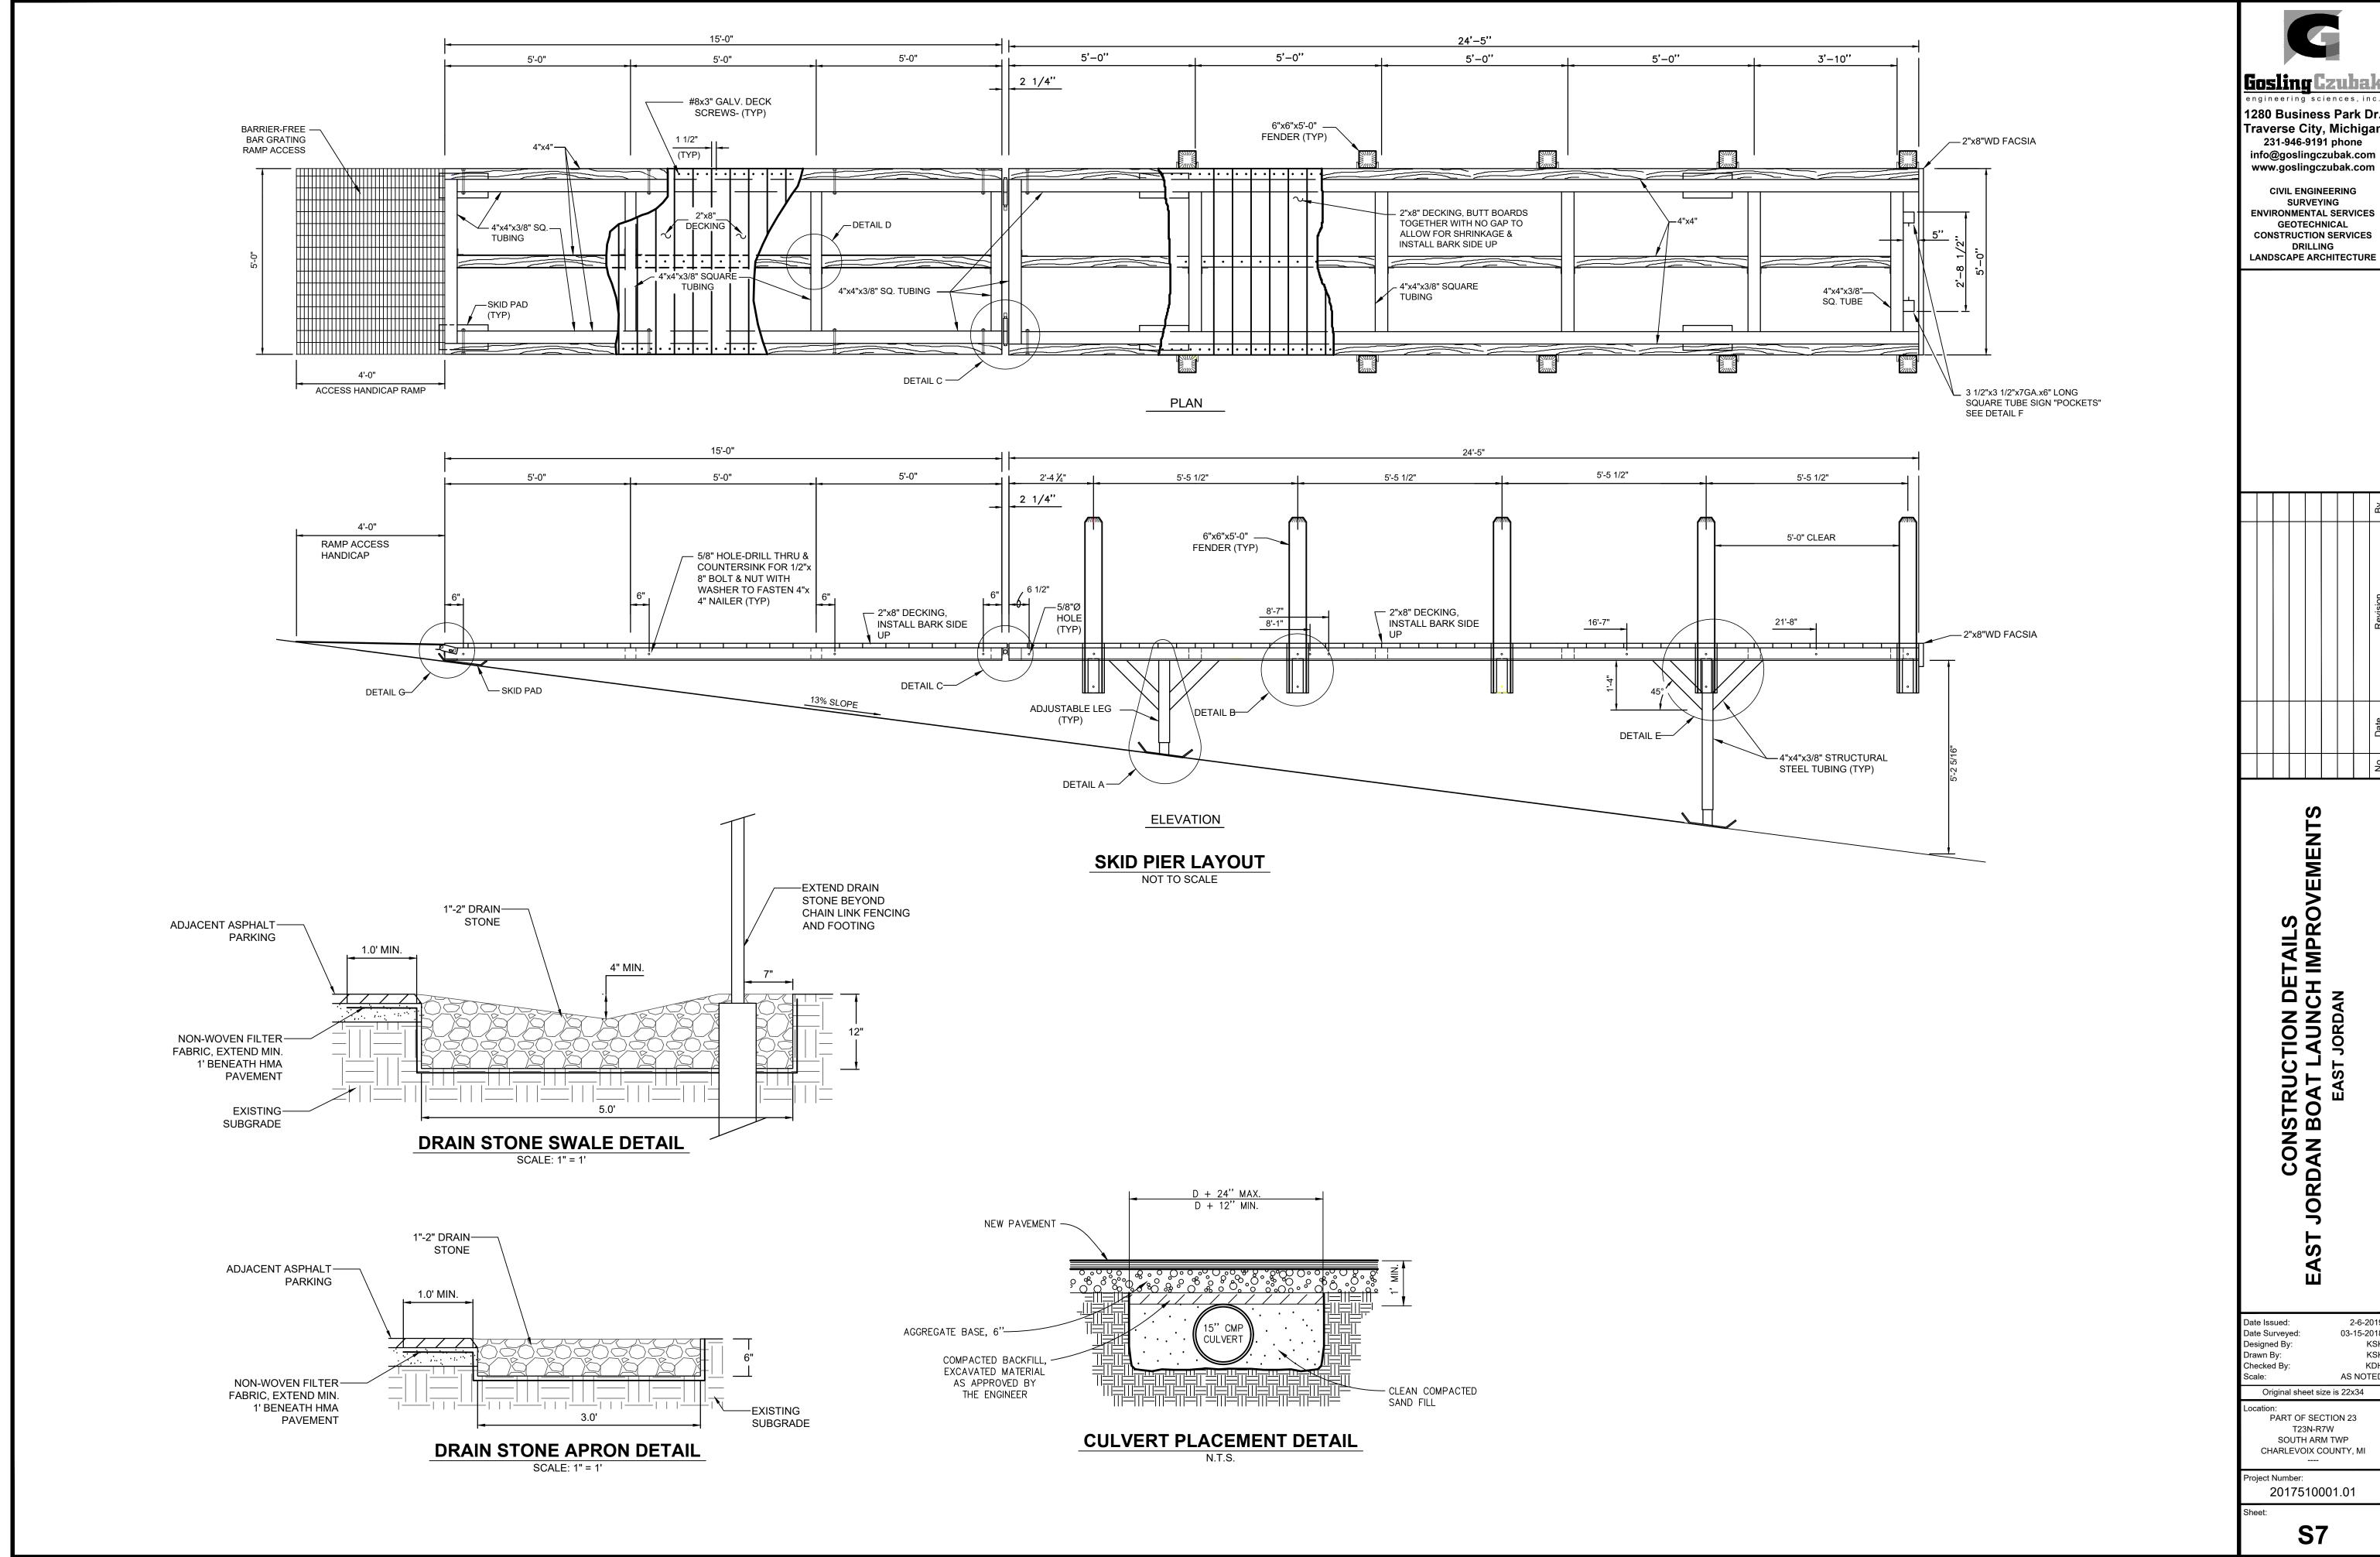


Gosling Czubal

1280 Business Park Dr. Traverse City, Michigan 231-946-9191 phone info@goslingczubak.com

03-15-2018 AS NOTED Original sheet size is 22x34

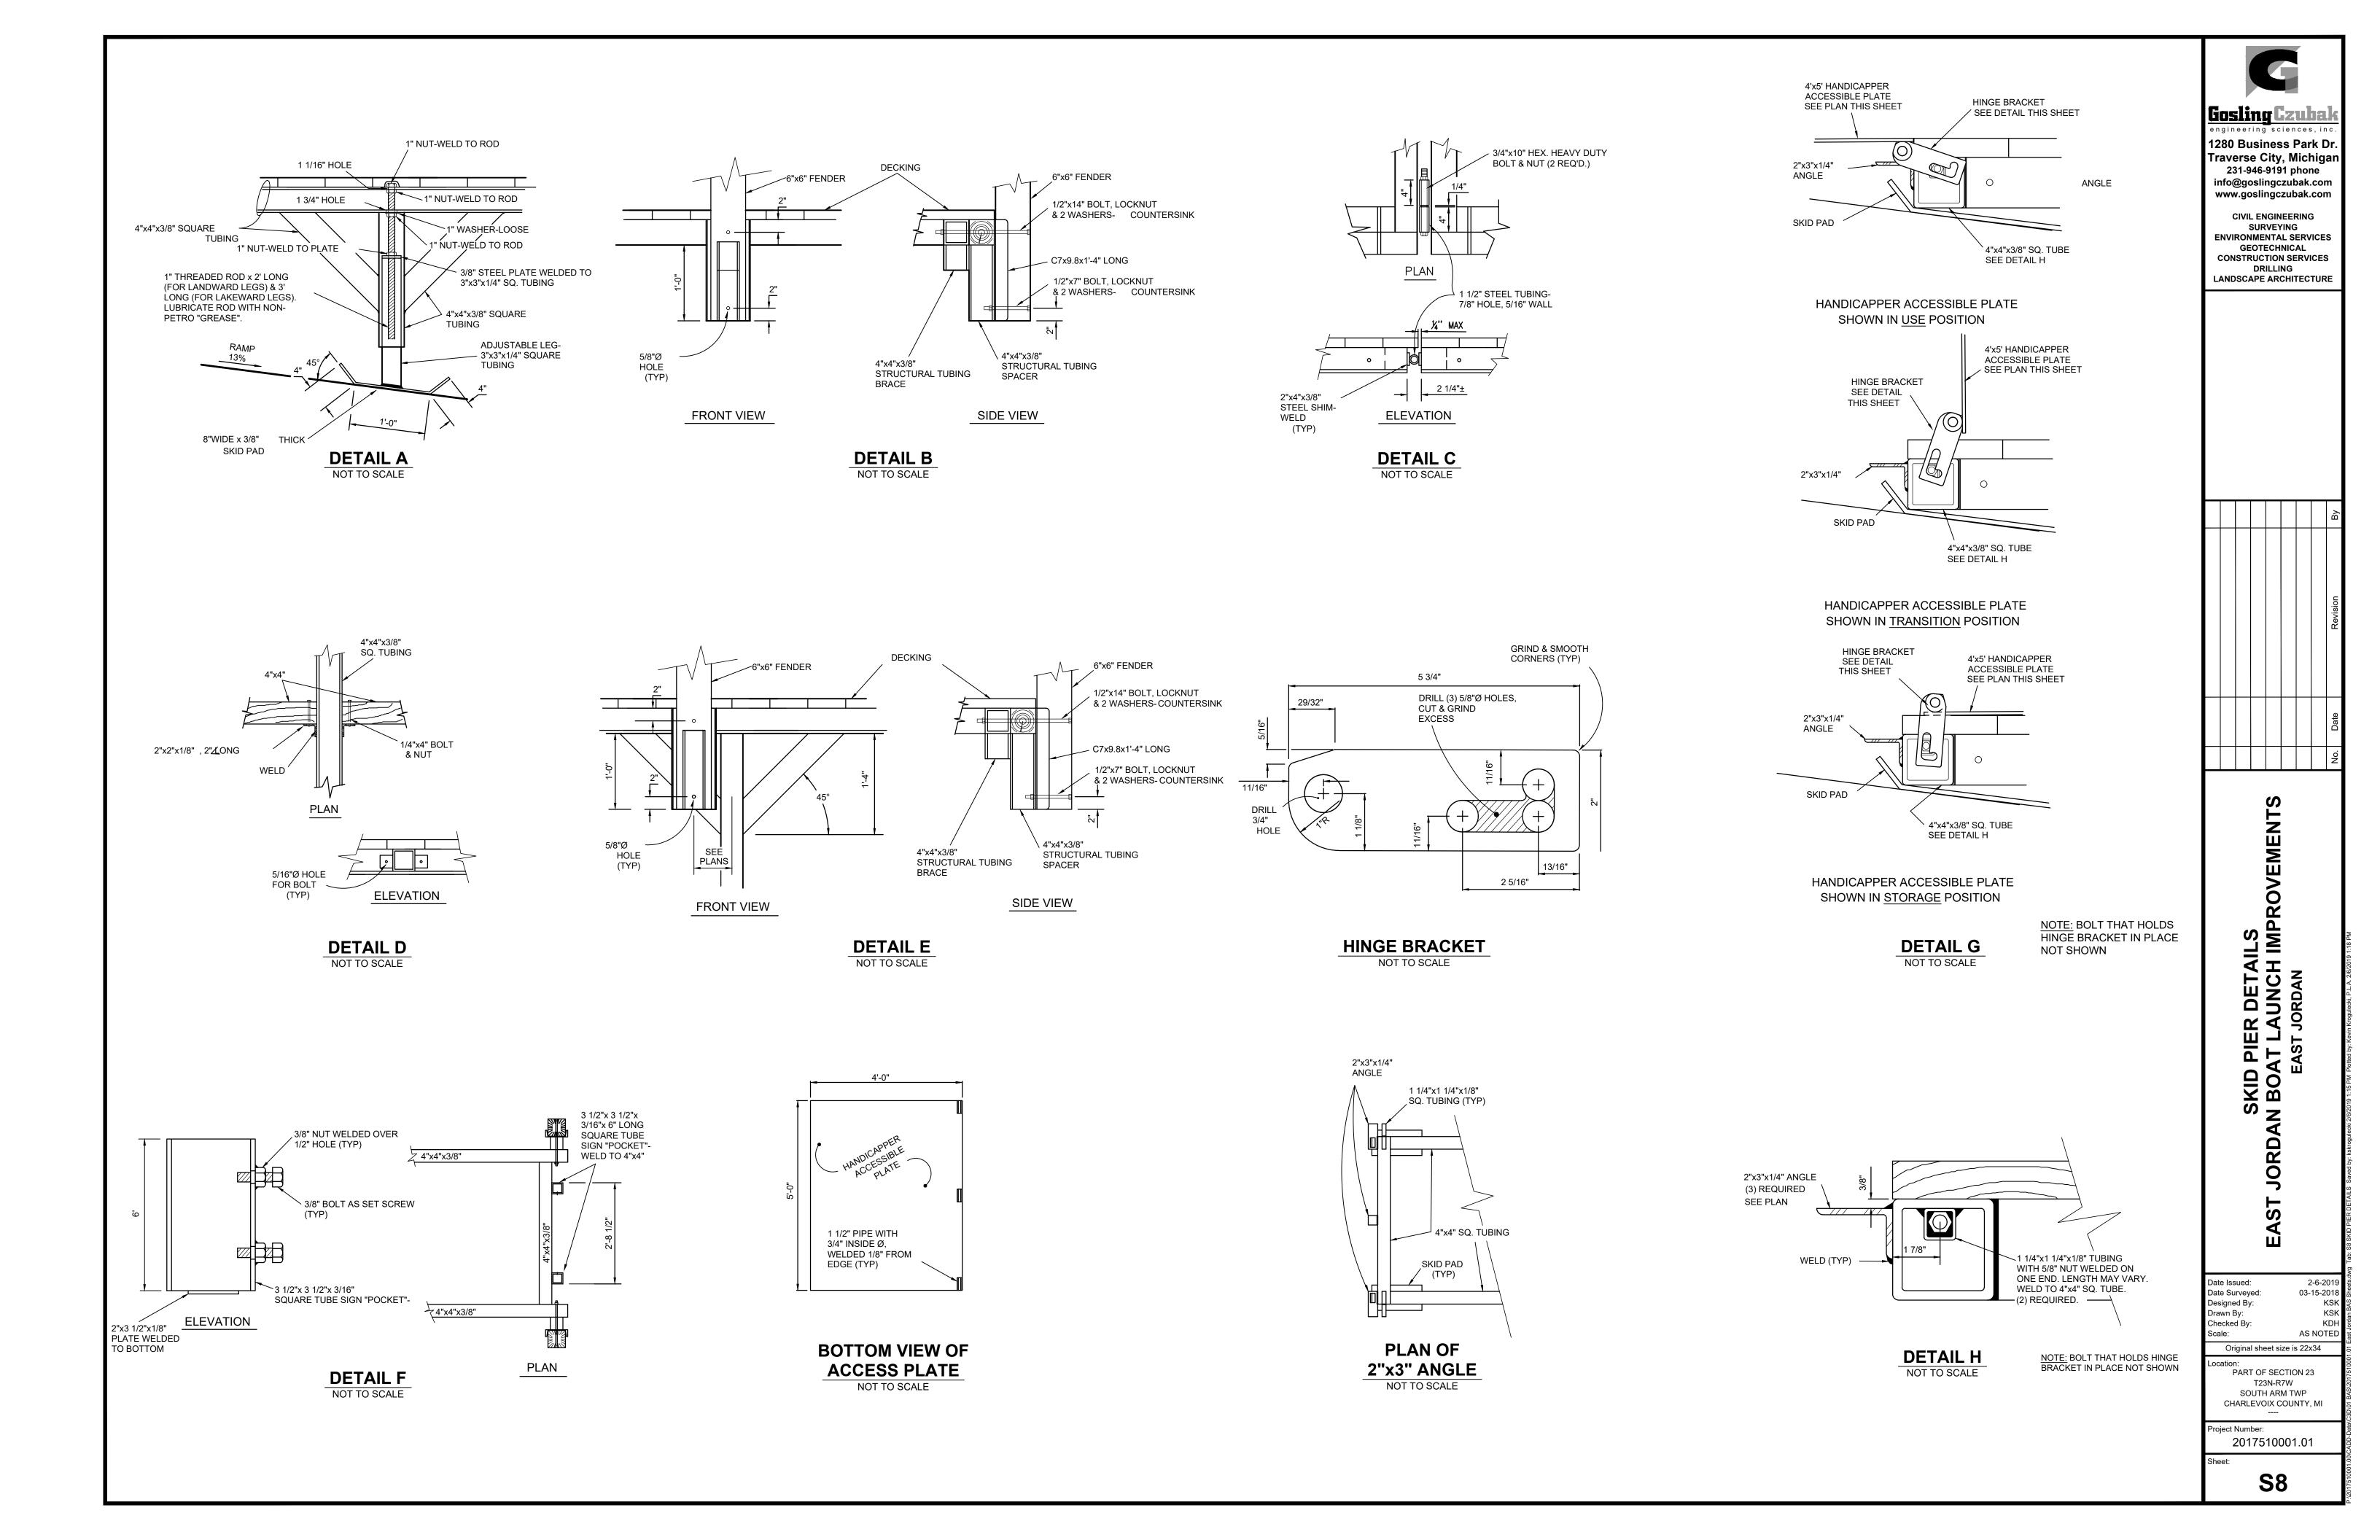

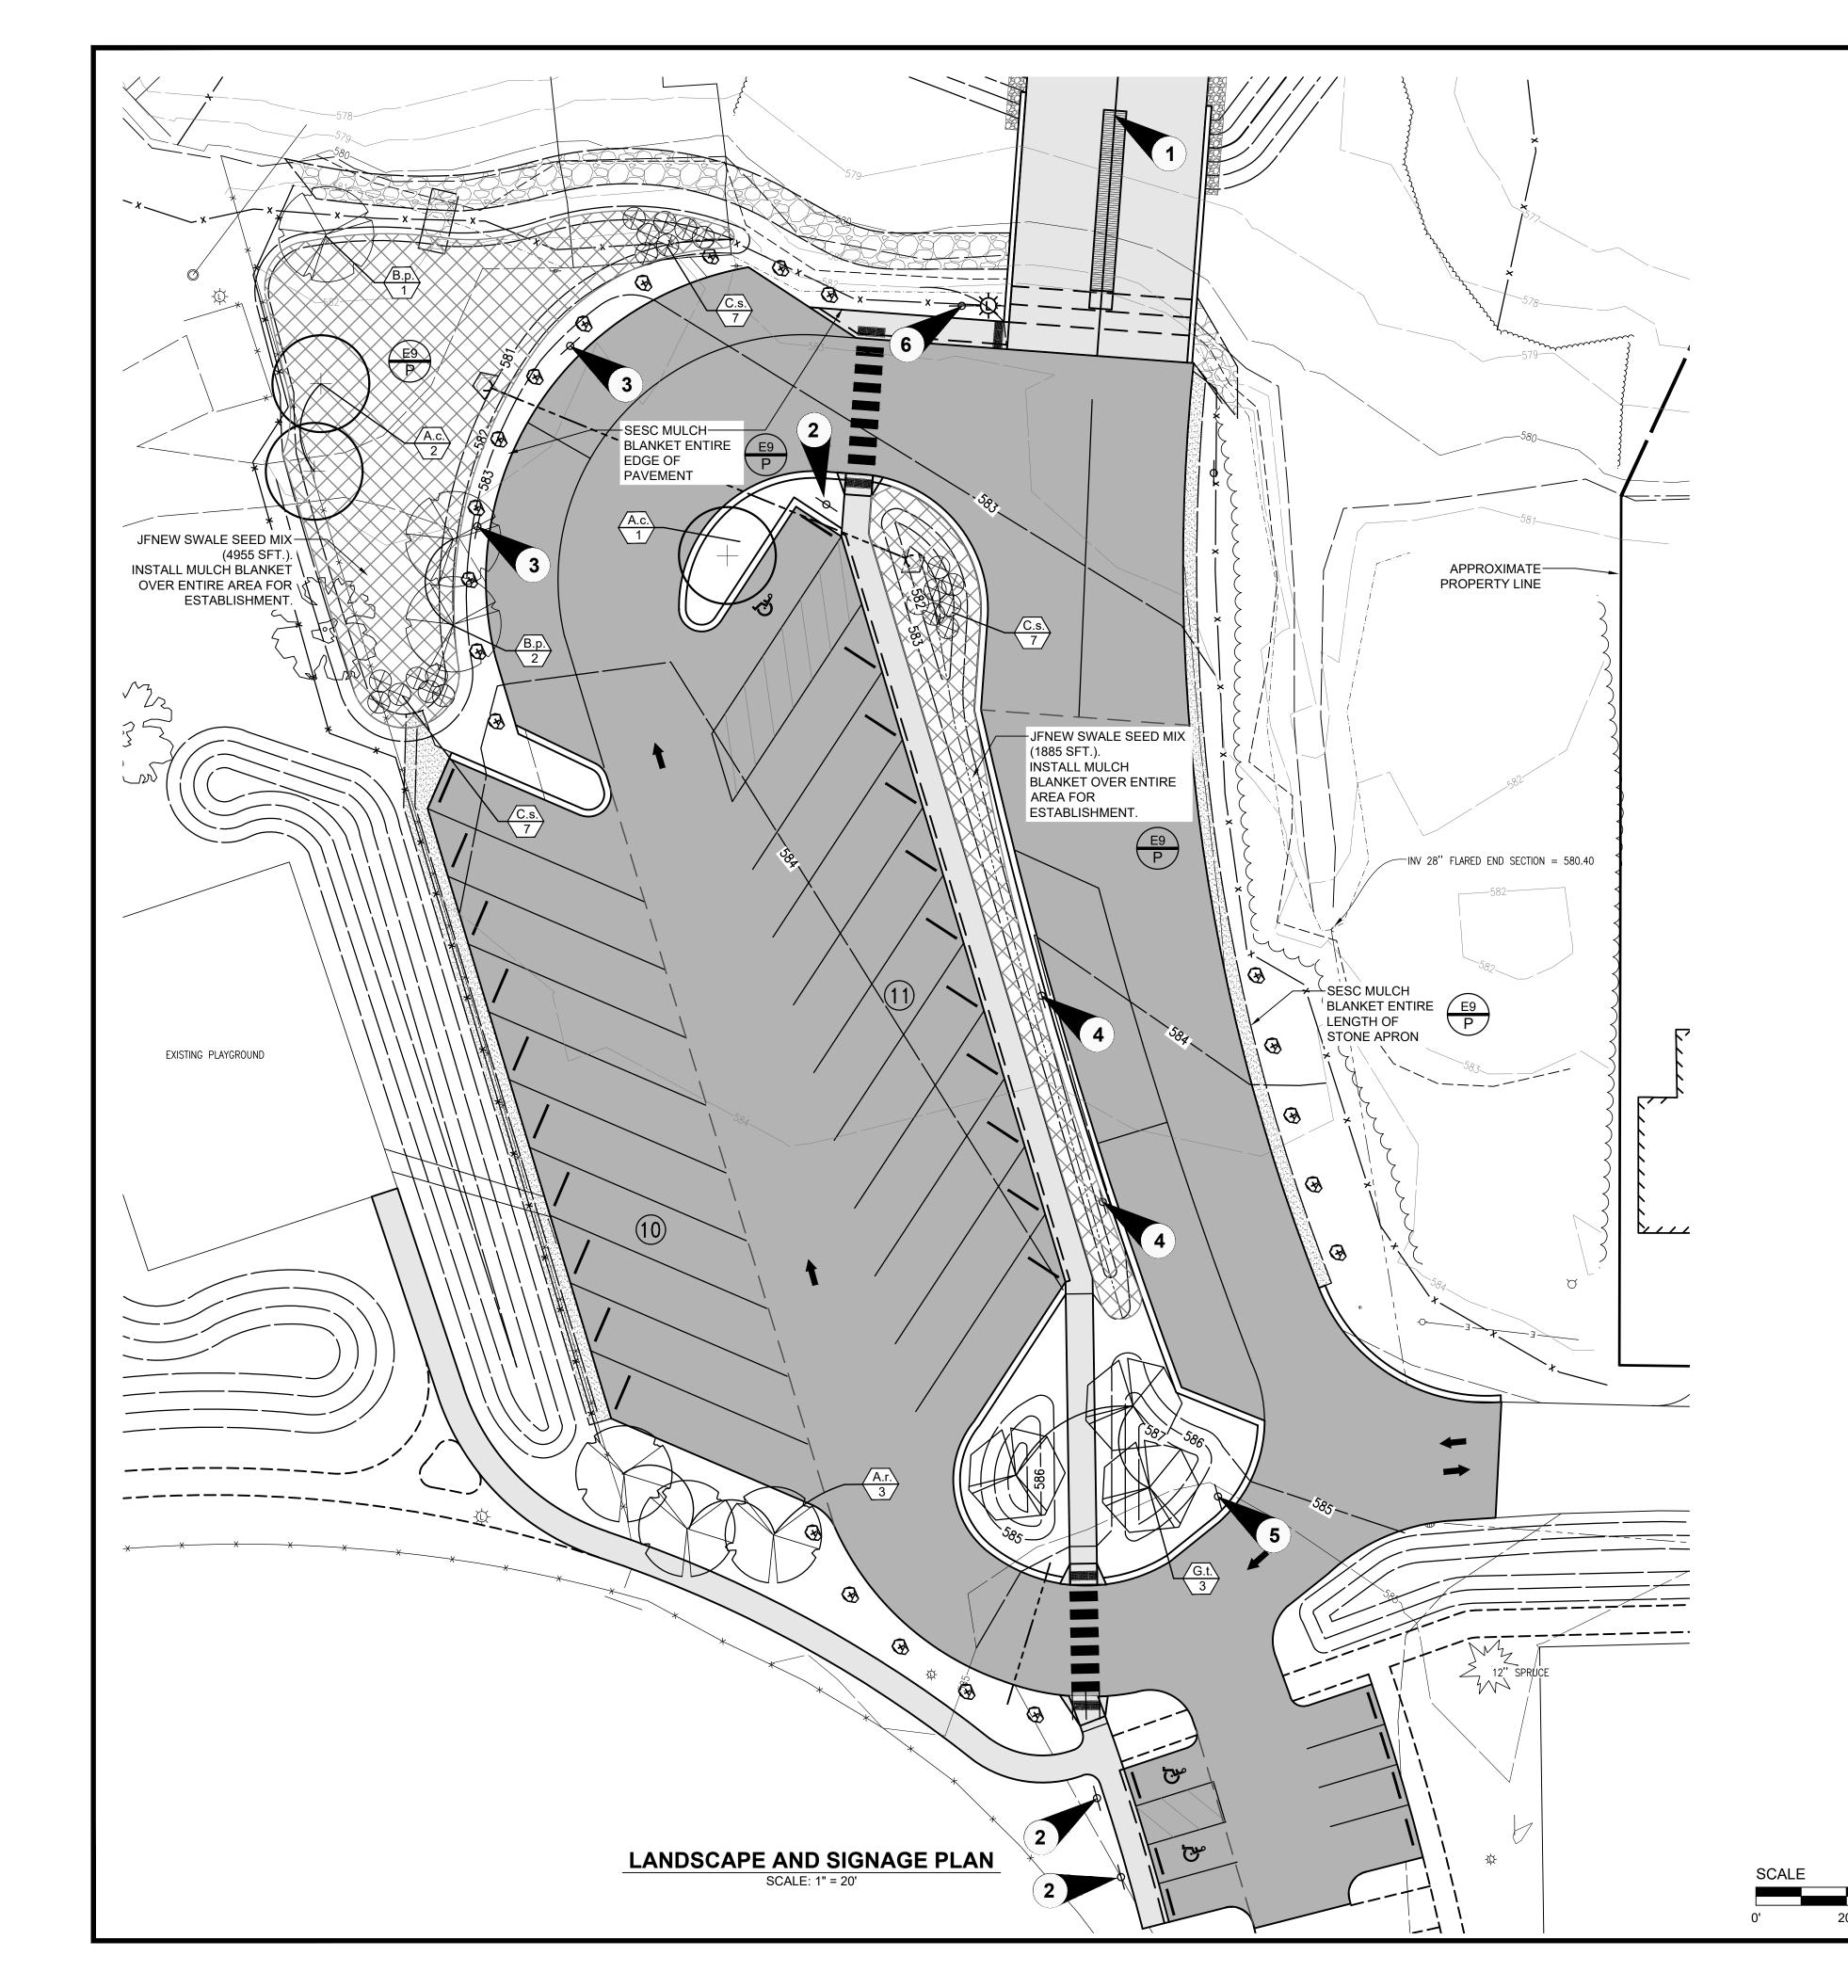


## Plant Schedule

| KEY |      | BOTANICAL NAME<br>COMMON NAME                               | MIN. REQ'D<br>SIZE   | QTY.     |
|-----|------|---|--|----------|
|     | A.r. | Acer rubrum 'Red Sunset' 'Red Sunset' Red Maple             | 2.5 cal. B&B   | 3        |
|     | В.р. | Betula papyrifera Paper or Canoe Birch                      | 12' Ht. B&B<br>Multi-Stem Clump<br>(Min 3-Stem)              | 3        |
| +   | A.c. | Amelanchier canadensis Shadblow Serviceberry                | 10' Ht. B&B<br>Multi-Stem                                    | 3        |
|     | G.t. | Gleditsia triacanthos 'shademaster' Shademaster Honeylocust | 2.5 cal. B&B   | 3        |
|     | G.t. | Cornus sericea 'Isanti'<br>Isanti Red Osier Dogwood         | #5 Pot   | 21       |
|     |      | JF NEW - SWALE SEED MIX                                     | Seed - Install at<br>minimum 33.75<br>PLS pounds per<br>acre | 6,840 SF |

## Sign Schedule

| SIGN | <u>TYPE</u> | <u>NOTES</u>  | SIGN SIDE "A"   | QUANTITY            |
|------|-------------|---|---|---------------------|
| 1    | С           | SIGN TO BE<br>DOUBLE<br>SIDED                                   | LAUNCH AREA<br>NO POWER LOADING<br>NO SWIMMING OR DIVING            | 1<br>(DOUBLE SIDED) |
| 2    | В           | SIGN SHALL BE<br>IN COMPLIANCE<br>WITH MMUTCD                   | RESERVED PARKING VAN ACCESSIBLE (R78VA)                             | 3                   |
| 3    | Α           | SIGN SHALL BE<br>IN COMPLIANCE<br>WITH MMUTCD                   | BOAT PREP LANE<br>NO PARKING<br>(UTILIZE 18"x12" REGULATORY SIGN)   | 2                   |
| 4    | А           | SIGN SHALL BE<br>IN COMPLIANCE<br>WITH MMUTCD                   | TIE-DOWN LANE<br>NO PARKING<br>(UTILIZE 18"X12"<br>REGULATORY SIGN) | 2                   |
| 5    | А           | ROTATED   | ↑ ONE-WAY   | 1                   |
| 6    | В           | RULES<br>LANGUAGE TO<br>BE PROVIDED<br>AND VERIFIED<br>BY OWNER | LAUNCH RULES SIGN   | 1                   |
| 7    | В           | SIGN PROVIDED<br>BY OWNER,<br>INSTALLED BY<br>CONTRACTOR        | MDNR WATERWAYS SIGN   | 1                   |

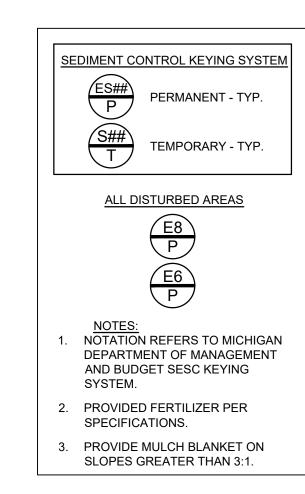



BM#1 (BENCH MARK) SPIKE IN LIGHT POLE EL=586 (NAVD 88)

PART OF SECTION 23 TOWN 32 NORTH, RANGE 4 WEST SOUTH ARM TWP., CHARLEVOIX CO., MI.



Know what's below.

Call before you dig.

THE LOCATION OF THE EXISTING UTILITIES, AS SHOWN ON THIS PLAN, ARE APPROXIMATE ONLY. IT SHALL BE THE RESPONSIBILITY OF THE CONTRACTOR TO VERIFY ACTUAL LOCATION AND DEPTH OF ALL EXISTING UTILITIES. THE OWNER AND THE SURVEYOR SHALL NOT BE RESPONSIBLE FOR ANY OMISSION OR VARIATION FROM THE LOCATION SHOWN. THE CONTRACTOR SHALL NOTIFY "MISS DIG" AT 1 (800) 482-7171 OR 811 THREE (3) WORKING DAYS PRIOR TO THE START OF CONSTRUCTION.

Ensling Czubak


engineering sciences, inc.

1280 Business Park Dr.

Traverse City, Michigan
231-946-9191 phone

info@goslingczubak.com
www.goslingczubak.com

CIVIL ENGINEERING
SURVEYING
ENVIRONMENTAL SERVICES
GEOTECHNICAL
CONSTRUCTION SERVICES
DRILLING
LANDSCAPE ARCHITECTURE

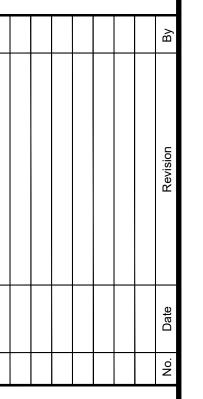

LANDSCAPE AND SIGNAGE PLAN EAST JORDAN BOAT LAUNCH IMPROVEMEI EAST JORDAN

Date Issued: 2-6-2019
Date Surveyed: 03-15-2018
Designed By: KSK
Drawn By: KSK
Checked By: KDH
Scale: ---Original sheet size is 22x34
Location:

orginal check ones is 22xc v.

Location:

PART OF SECTION 23

T23N-R7W

SOUTH ARM TWP

CHARLEVOIX COUNTY MI

SOUTH ARM TWP
CHARLEVOIX COUNTY, MI
---Project Number:


2017510001.01 Sheet:

## Signage Notes


- 1. REMOVE AND SALVAGE ALL EXISTING SIGNAGE WITHIN THE LIMITS IF CONSTRUCTION ACTIVITIES. SALVAGED SIGNAGE SHALL REMAIN PROPERTY OF THE OWNER.
- 2. PREVENT DAMAGE OF SIGNAGE TO BE RELOCATED AND REUSED. IF DAMAGE TO REUSABLE SIGNAGE OCCURS DURING REMOVAL, THE CONTRACTOR SHALL REPLACE SIGNAGE OR REIMBURSE THE OWNER.
- SUBMIT SIGNAGE PACKAGE INFORMATION FOR REVIEW AND APPROVAL BY THE PROFESSIONAL PRIOR TO FABRICATION AND INSTALLATION.

## General Landscape Notes

- 1. CONTRACTOR SHALL ADEQUATELY DELINEATE PLANTING AREAS WITH MARKING PAINT OR OTHER APPROVED METHOD PRIOR TO INSTALLATION FOR APPROVAL BY LANDSCAPE ARCHITECT.
- 2. REFER TO SPECIFICATION 02950 FOR LANDSCAPING INSTALLATION INFORMATION.
- 3. IN CASE OF A DISCREPANCY, THE NUMBER OF TREE/SHRUB SYMBOLS SHOWN ON THE PLANS SHALL TAKE PRECEDENCE OVER QUANTITY ON NUMERICAL LABEL OR PLANT SCHEDULE.
- 4. PROVIDE A MINIMUM 3" DEPTH OF RED PINE LANDSCAPE MULCH (EQUAL TO RED PINE MULCH FROM TRAVERSE OUTDOOR, TRAVERSE CITY, MI) IN ALL PLANTING BEDS AS INDICATED ON PLANS. SUBMIT A SAMPLE OF THE MULCH TO THE LANDSCAPE ARCHITECT FOR APPROVAL PRIOR TO INSTALLATION. FINISHED GRADE OF MULCH SHALL BE FLUSH WITH GRADE OF ALL ADJACENT PAVING AND CURBS TO ALLOW FOR SETTLING.
- 5. THE LANDSCAPE CONTRACTOR SHALL PROVIDE PLANTING MIX FOR PLANTING MEDIUM FOR THE TREES AND SHRUBS. PROVIDE PLANTING MIX SAMPLE RATIO FOR APPROVAL BY LANDSCAPE ARCHITECT.
- 6. COORDINATE THE LANDSCAPE INSTALLATION WITH THE INSTALLATION WITH THE FINAL SITE PARKING AND PAVING PLAN. COORDINATE THE LANDSCAPE INSTALLATION TO INSURE VISIBILITY OF ALL TRAFFIC SIGNAGE. COORDINATE THE LANDSCAPE INSTALLATION WITH UTILITY LOCATIONS.
- 7. STAKE THE LOCATIONS OF ALL TREES AND MASS PLANTING AREAS AND OBTAIN APPROVAL OF THE LANDSCAPE ARCHITECT PRIOR TO INSTALLATION. MAKE MINOR ADJUSTMENTS IN THE TREE LOCATIONS REQUIRED DUE TO UTILITY ITEMS.
- 8. TREES SHALL BE SELECTED WITH FORMS ADAPTABLE TO PLACEMENT ADJACENT TO SIDEWALKS AND VEHICULAR USE AREAS. TREES SHALL HAVE FORMS ADAPTABLE TO FUTURE PRUNING FOR PEDESTRIAN AND VEHICULAR CLEARANCE.
- 9. ALL CONTAINER GROWN MATERIAL SHALL BE THOROUGHLY HAND WATERED UPON ARRIVAL, WHILE IN THE CONTAINERS, BEFORE PLANTING. DO NOT BIND OR STRAP THE TRUNKS IN THE REMOVAL FROM THE TRUCKS. PROTECT THE TRUNKS AT ALL TIMES.
- 10. PROVIDE A MINIMUM 3'-0" DIAMETER TREE WELL WITH A 4" SAUCER FOR ALL TREES LOCATED IN TURF AREAS. PROVIDE 3" DEPTH OF MULCH INSIDE SAUCERS. REVIEW SUBSURFACE DRAINAGE CONDITIONS. INSTALL TREES "HIGH" IF NECESSARY, DUE TO SUBSURFACE CONDITIONS.
- 11. PRUNE ANY ADDITIONAL TREES AS REQUIRED BY THE LANDSCAPE ARCHITECT, GENERAL CONTRACTOR OR OWNER.
- 12. ALL MASS PLANTINGS SHALL BE EVENLY SPACED AS SHOWN ON PLANS TO ENSURE EVEN COVERAGE. SET PLANTS OFF CURBS AND WALKS TO PREVENT OVERGROWTH INTO UNWANTED AREAS.

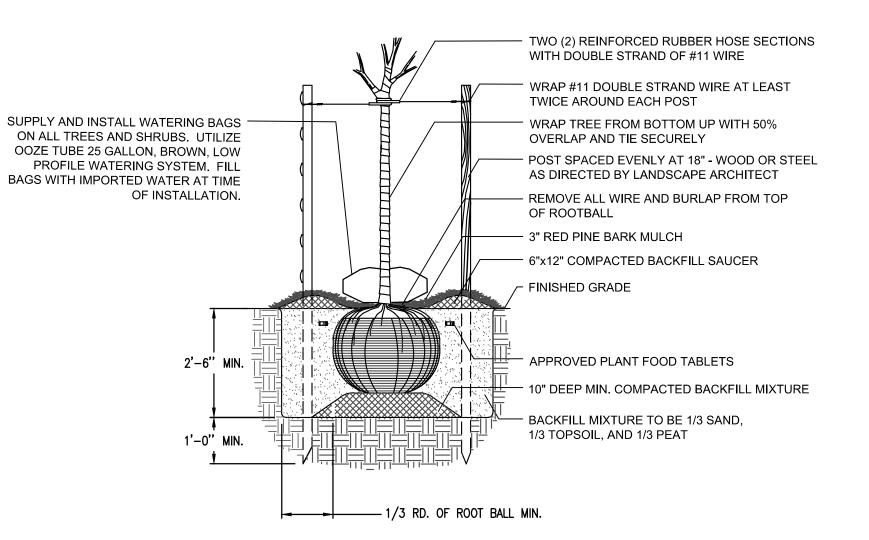


## TREE INSTALLATION DETAIL NOT TO SCALE

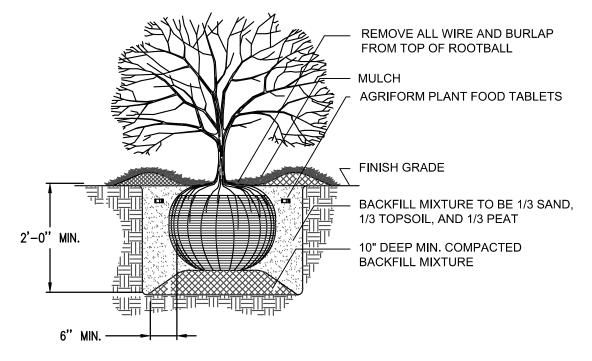

SHRUB INSTALLATION DETAIL


NOT TO SCALE

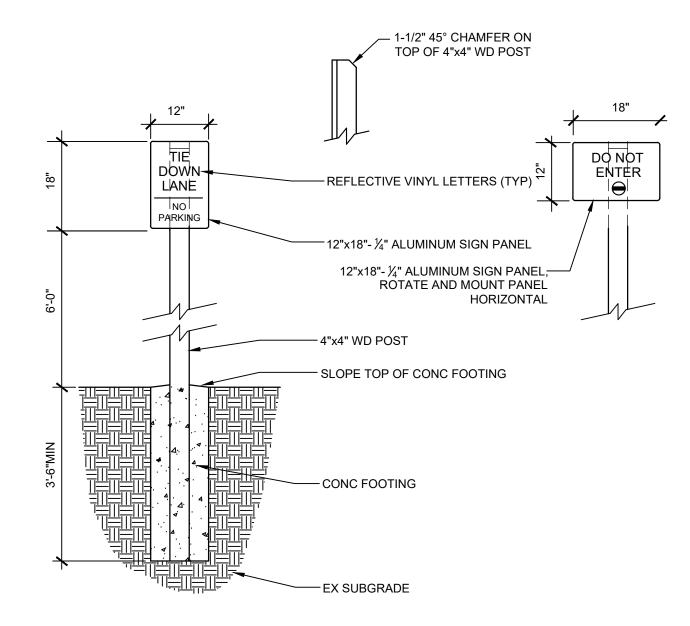

SIGN TYPE "A"

DIRECTIONAL SIGN DETAIL


NOT TO SCALE

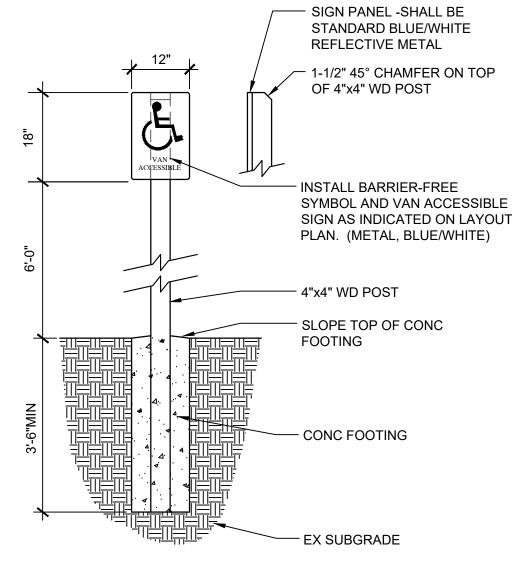


SIGN TYPE "B"

BARRIER-FREE SIGN POST DETAIL

NOT TO SCALE

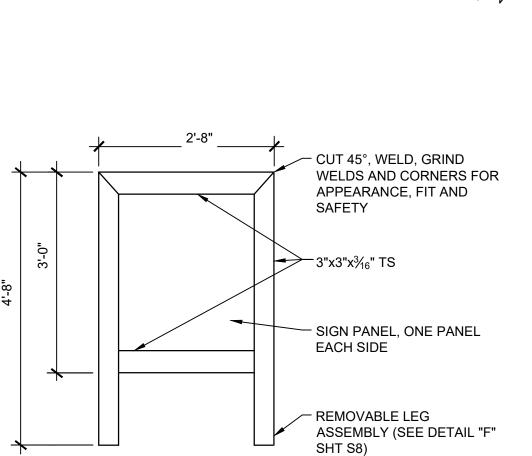

SIGN TYPE "C"
SKID PIER SIGN DETAIL
NOT TO SCALE

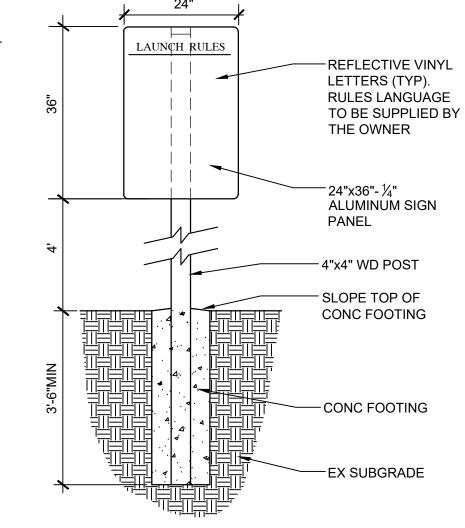

- 1-1/2" 45° CHAMFER

ON TOP OF 4"x4" WD

SIGN TYPE "D"
RULES SIGN DETAIL
NOT TO SCALE

engineering sciences, inc.


1280 Business Park Dr.
Traverse City, Michigan
231-946-9191 phone
info@goslingczubak.com
www.goslingczubak.com
CIVIL ENGINEERING
SURVEYING

**ENVIRONMENTAL SERVICES** 

GEOTECHNICAL

CONSTRUCTION SERVICES
DRILLING

LANDSCAPE ARCHITECTURE

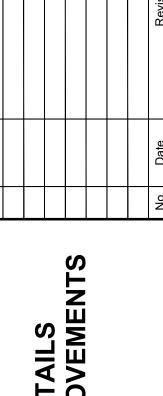

LANDSCAPE AND SIGNAGE DETAII EAST JORDAN BOAT LAUNCH IMPROVE EAST JORDAN

Date Issued: 2-6-2019
Date Surveyed: 03-15-2018
Designed By: KSK
Drawn By: KSK
Checked By: KDH
Scale: ----

Original sheet size is 22x34

Location:
PART OF SECTION 23
T23N-R7W
SOUTH ARM TWP
CHARLEVOIX COUNTY, MI

Project Number:

2017510001.01 Sheet:

L2