# Issue Date


02/01/2023 Project No.

WWTP HEADWORKS ADDITION

FOR

# LITTLE RIVER BAND OF OTTAWA INDIANS

MANISTEE, MANISTEE COUNTY, MICHIGAN

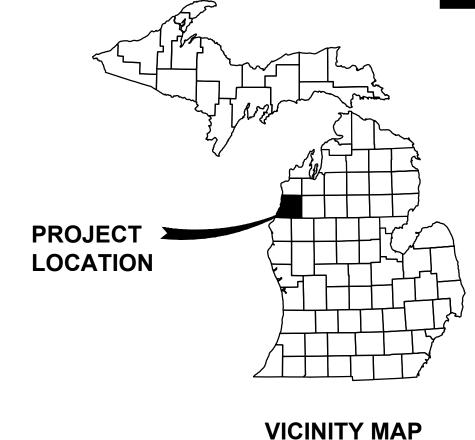

# **OWNER**

LITTLE RIVER BAND OF OTTAWA INDIANS

# **ENGINEER**

GOSLING CZUBAK ENGINEERING SCIENCES, INC. 1280 BUSINESS PARK DRIVE TRAVERSE CITY, MICHIGAN, 49686-8607 231.946.9191 - 800.968.1062 www.goslingczubak.com info@goslingczubak.com

## UTILITY CONTACTS

NAME OF OWNER

TYPE OF UTILITY

MERRITT ENERGY 4000 FISK ROAD

MANISTEE, MI 49660 (231)723-6587


AT&T

LRBOI

**TELEPHONE** 

GAS

MANISTEE, MI 49660 (231)398-2299 CONTACT: GARY LEWIS WATER

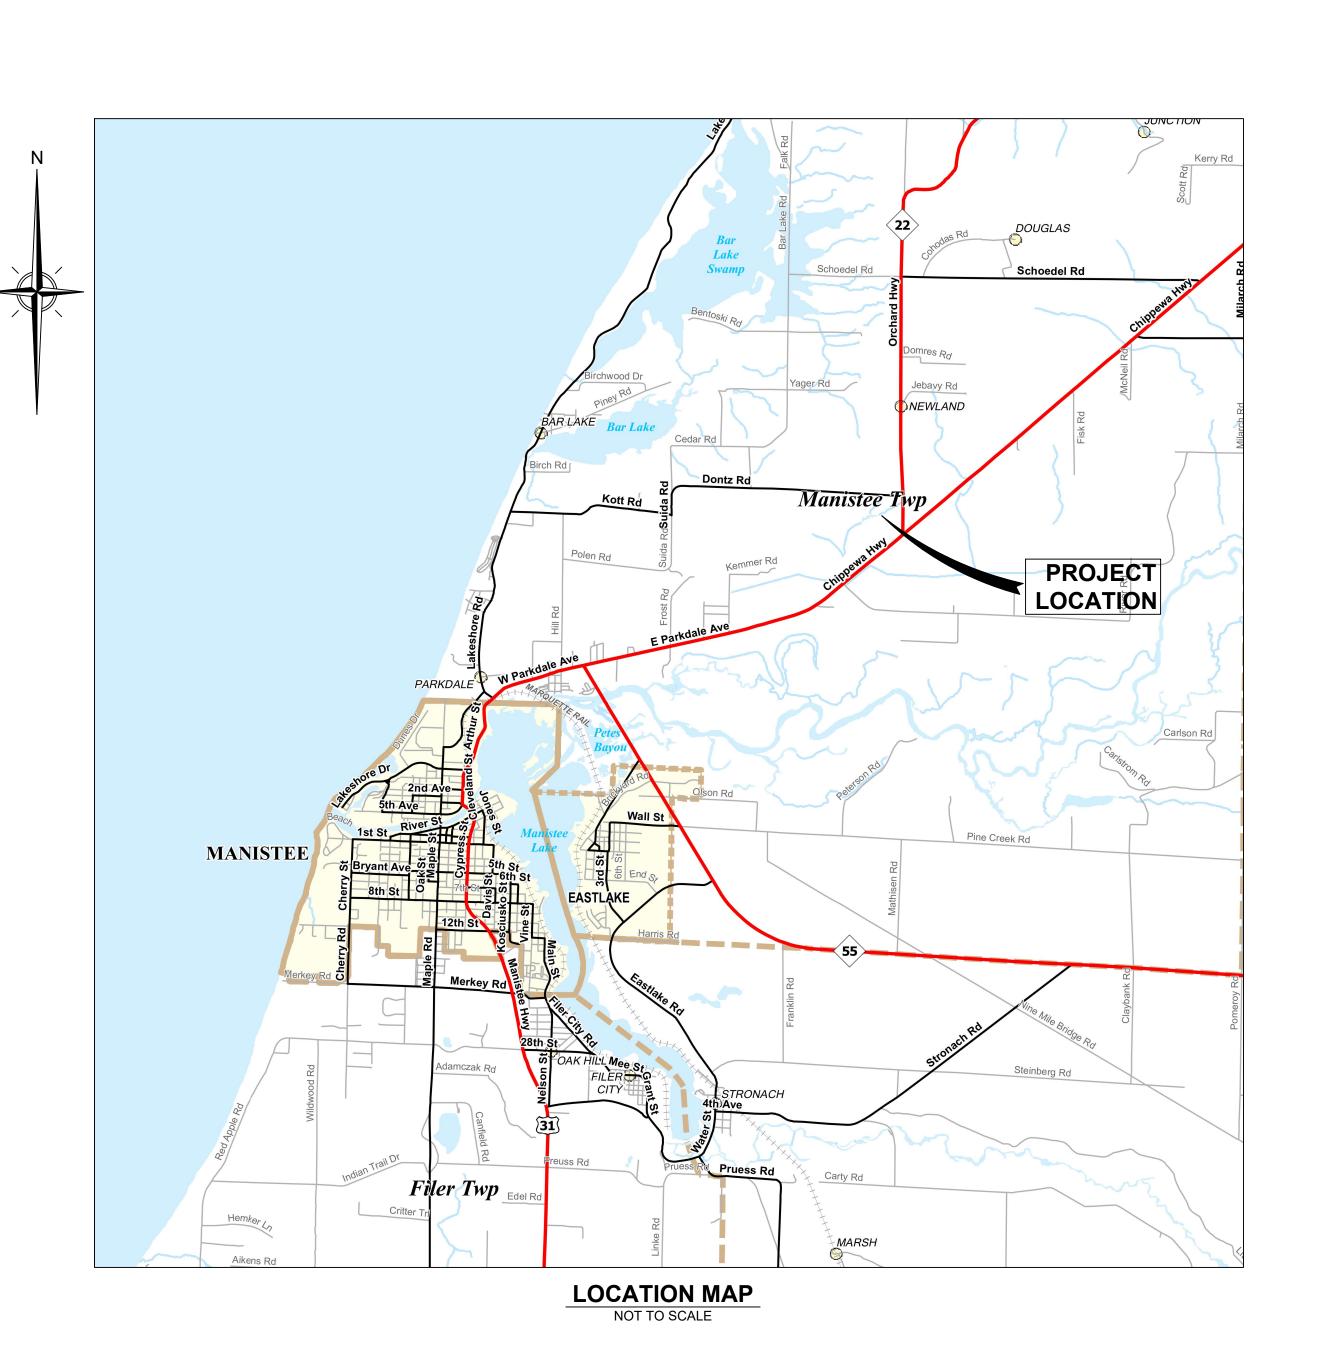

# **Drawing Index**

COVER - COVER

C-O-EXISTING CONDITIONS & DEMOLITION PLAN

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M-1- PROCESS MECHANICAL

M-2 - PROCESS ELECTRICAL

- PROCESS ELECTRICAL

- ELECTRICAL LEGEND, SCHEDULES & NOTES

E-1 - PROCESS ELECTRICAL FLOOR PLAN

E-2- ELECTRICAL RISER DIAGRAM & PNL SCHEDULES

## **PUBLIC UTILITIES**

THE EXISTING UTILITIES LISTED BELOW AND SHOWN ON THESE PLANS REPRESENT THE BEST INFORMATION AVAILABLE. THIS INFORMATION DOES NOT RELIEVE THE CONTRACTOR OF THE RESPONSIBILITY TO BE SATISFIED AS TO ITS ACCURACY AND THE LOCATION OF EXISTING UTILITIES. THE CONTRACTOR SHALL NOTIFY "MISS DIG" (1-800-482-7171) THREE WORK-ING DAYS PRIOR TO THE START OF CONSTRUCTION.





THE LOCATION OF THE EXISTING UTILITIES, AS SHOWN ON THIS PLAN, ARE APPROXIMATE ONLY. IT SHALL BE THE RESPONSIBILITY OF THE CONTRACTOR TO VERIFY ACTUAL LOCATION AND DEPTH OF ALL EXISTING UTILITIES. THE OWNER AND THE SURVEYOR SHALL NOT BE RESPONSIBLE FOR ANY OMISSION OR VARIATION FROM THE LOCATION SHOWN. THE CONTRACTOR SHALL NOTIFY "MISS DIG" AT 1 (800) 482-7171 OR 811 THREE (3) WORKING DAYS PRIOR TO THE START OF CONSTRUCTION.


022388001.0 Sheet


ORIGINAL SHEET SIZE IS 22x34 - HALF SCALE SHEET IS 11X17


COVER

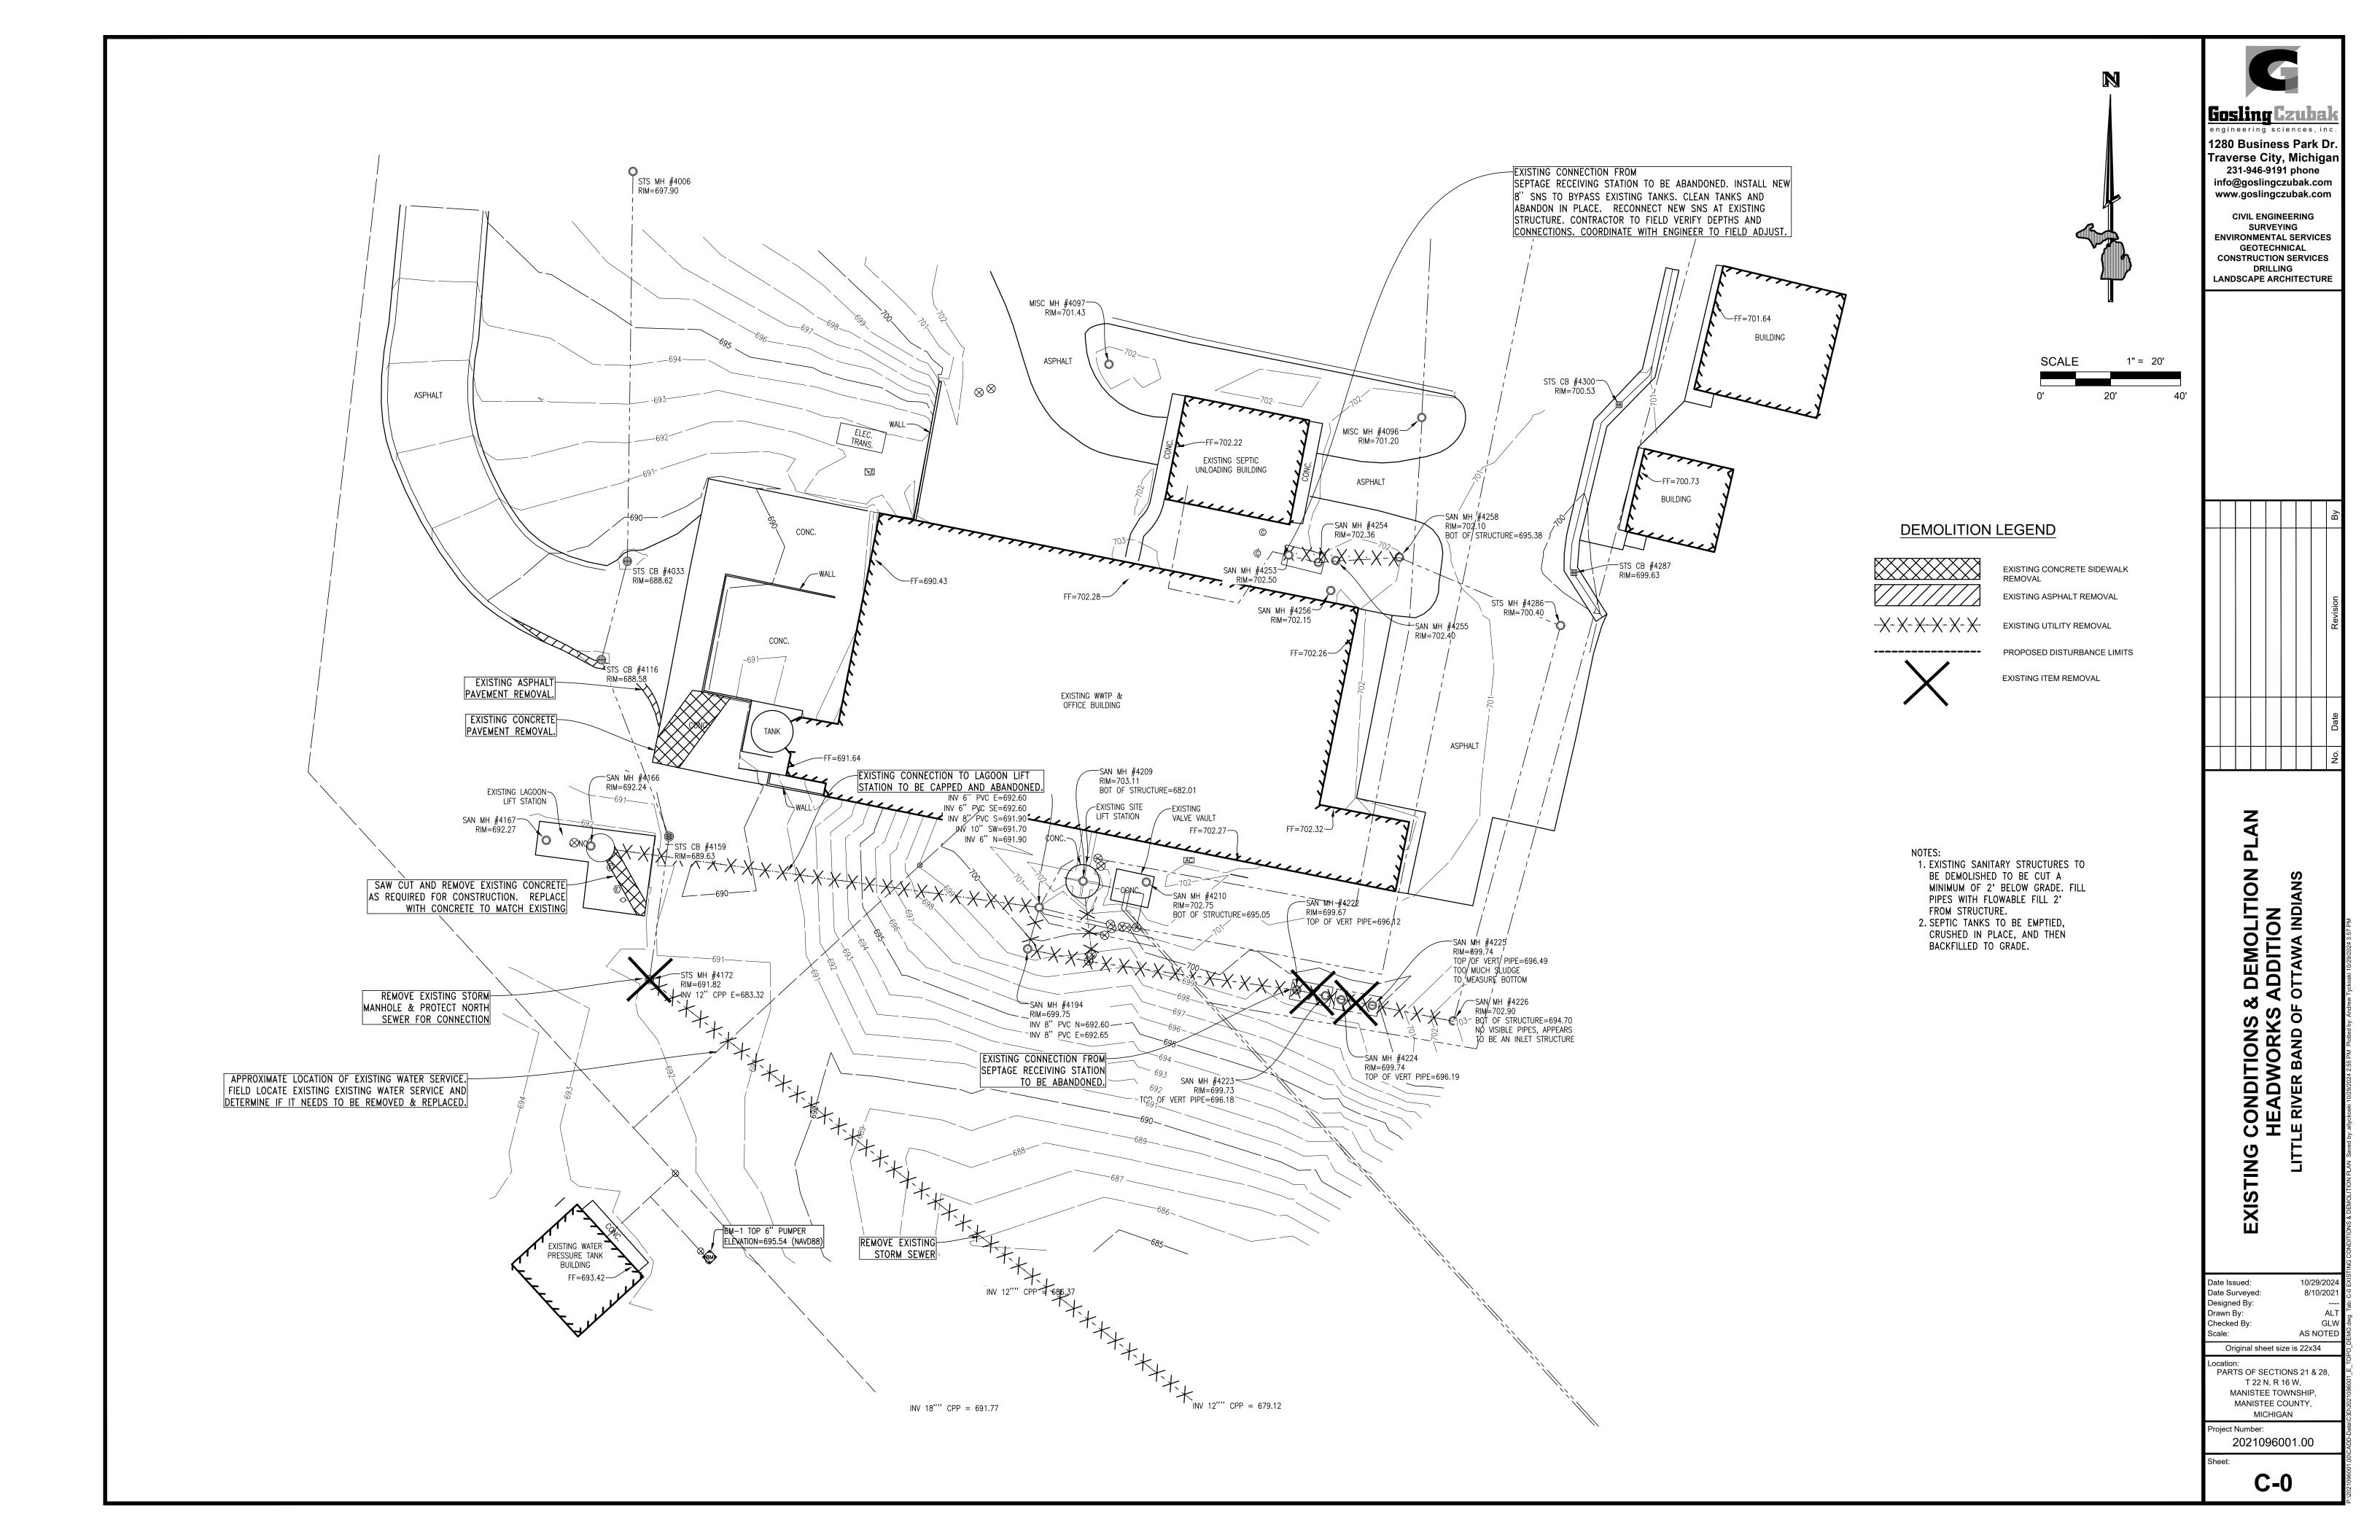

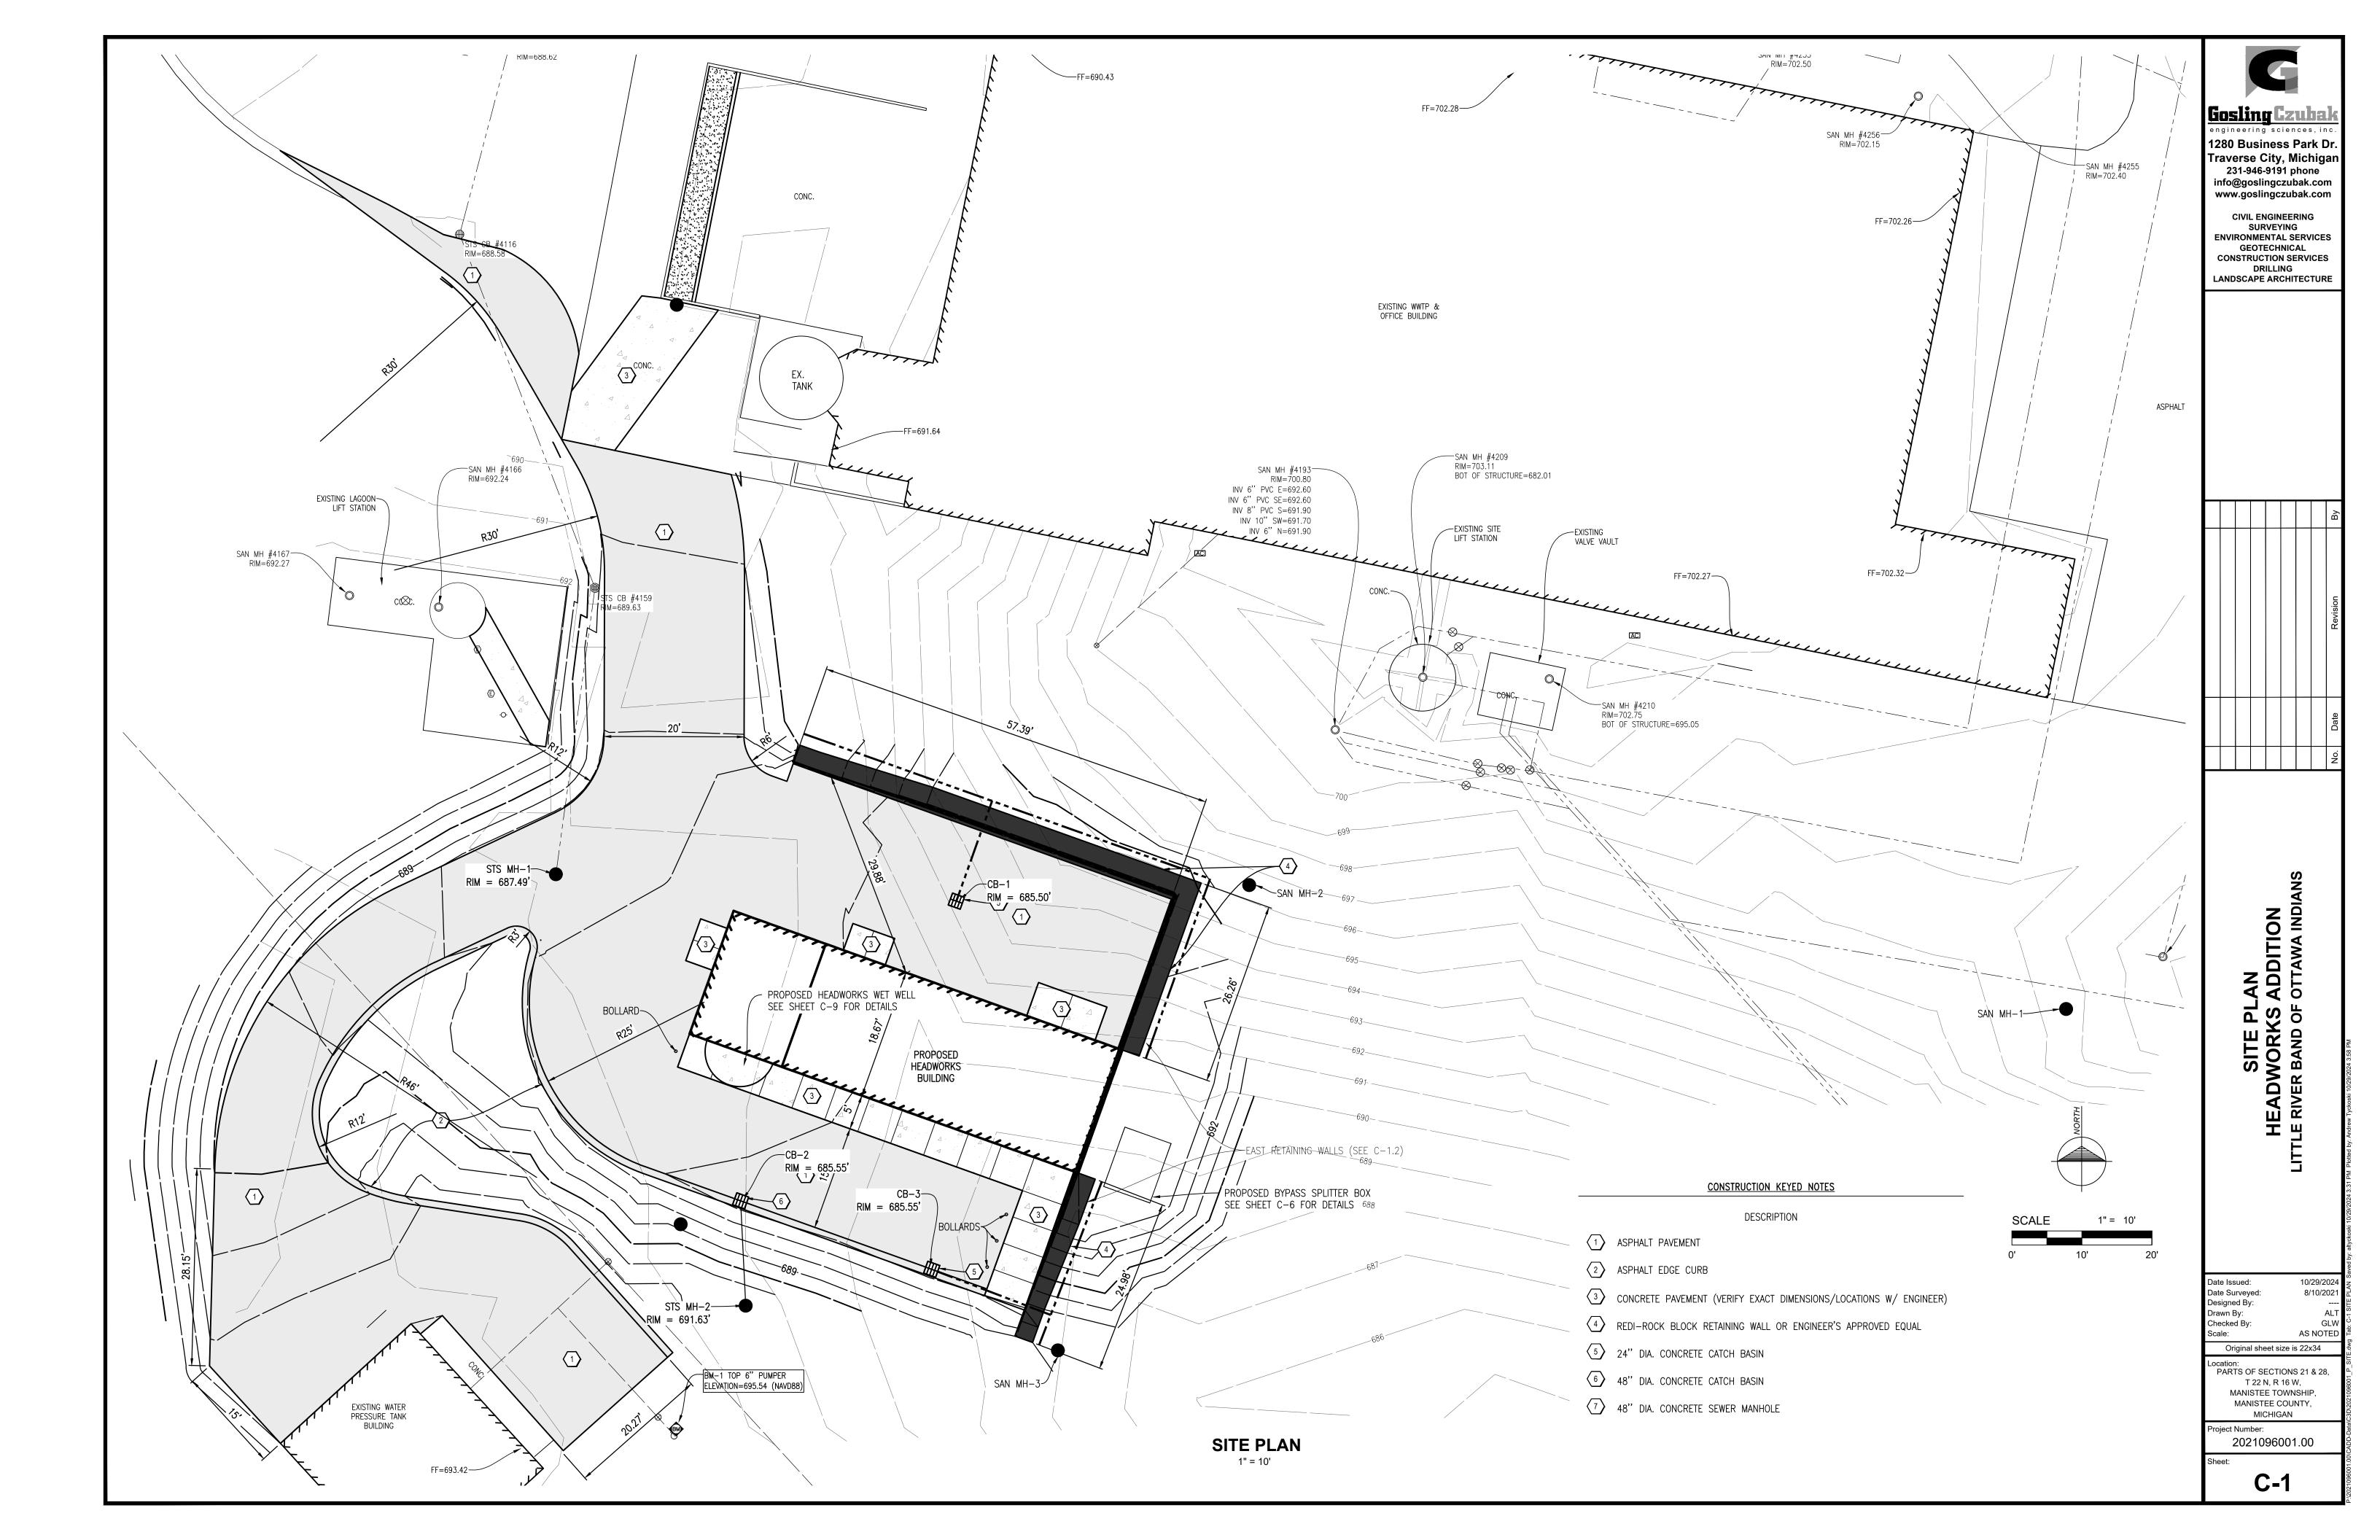

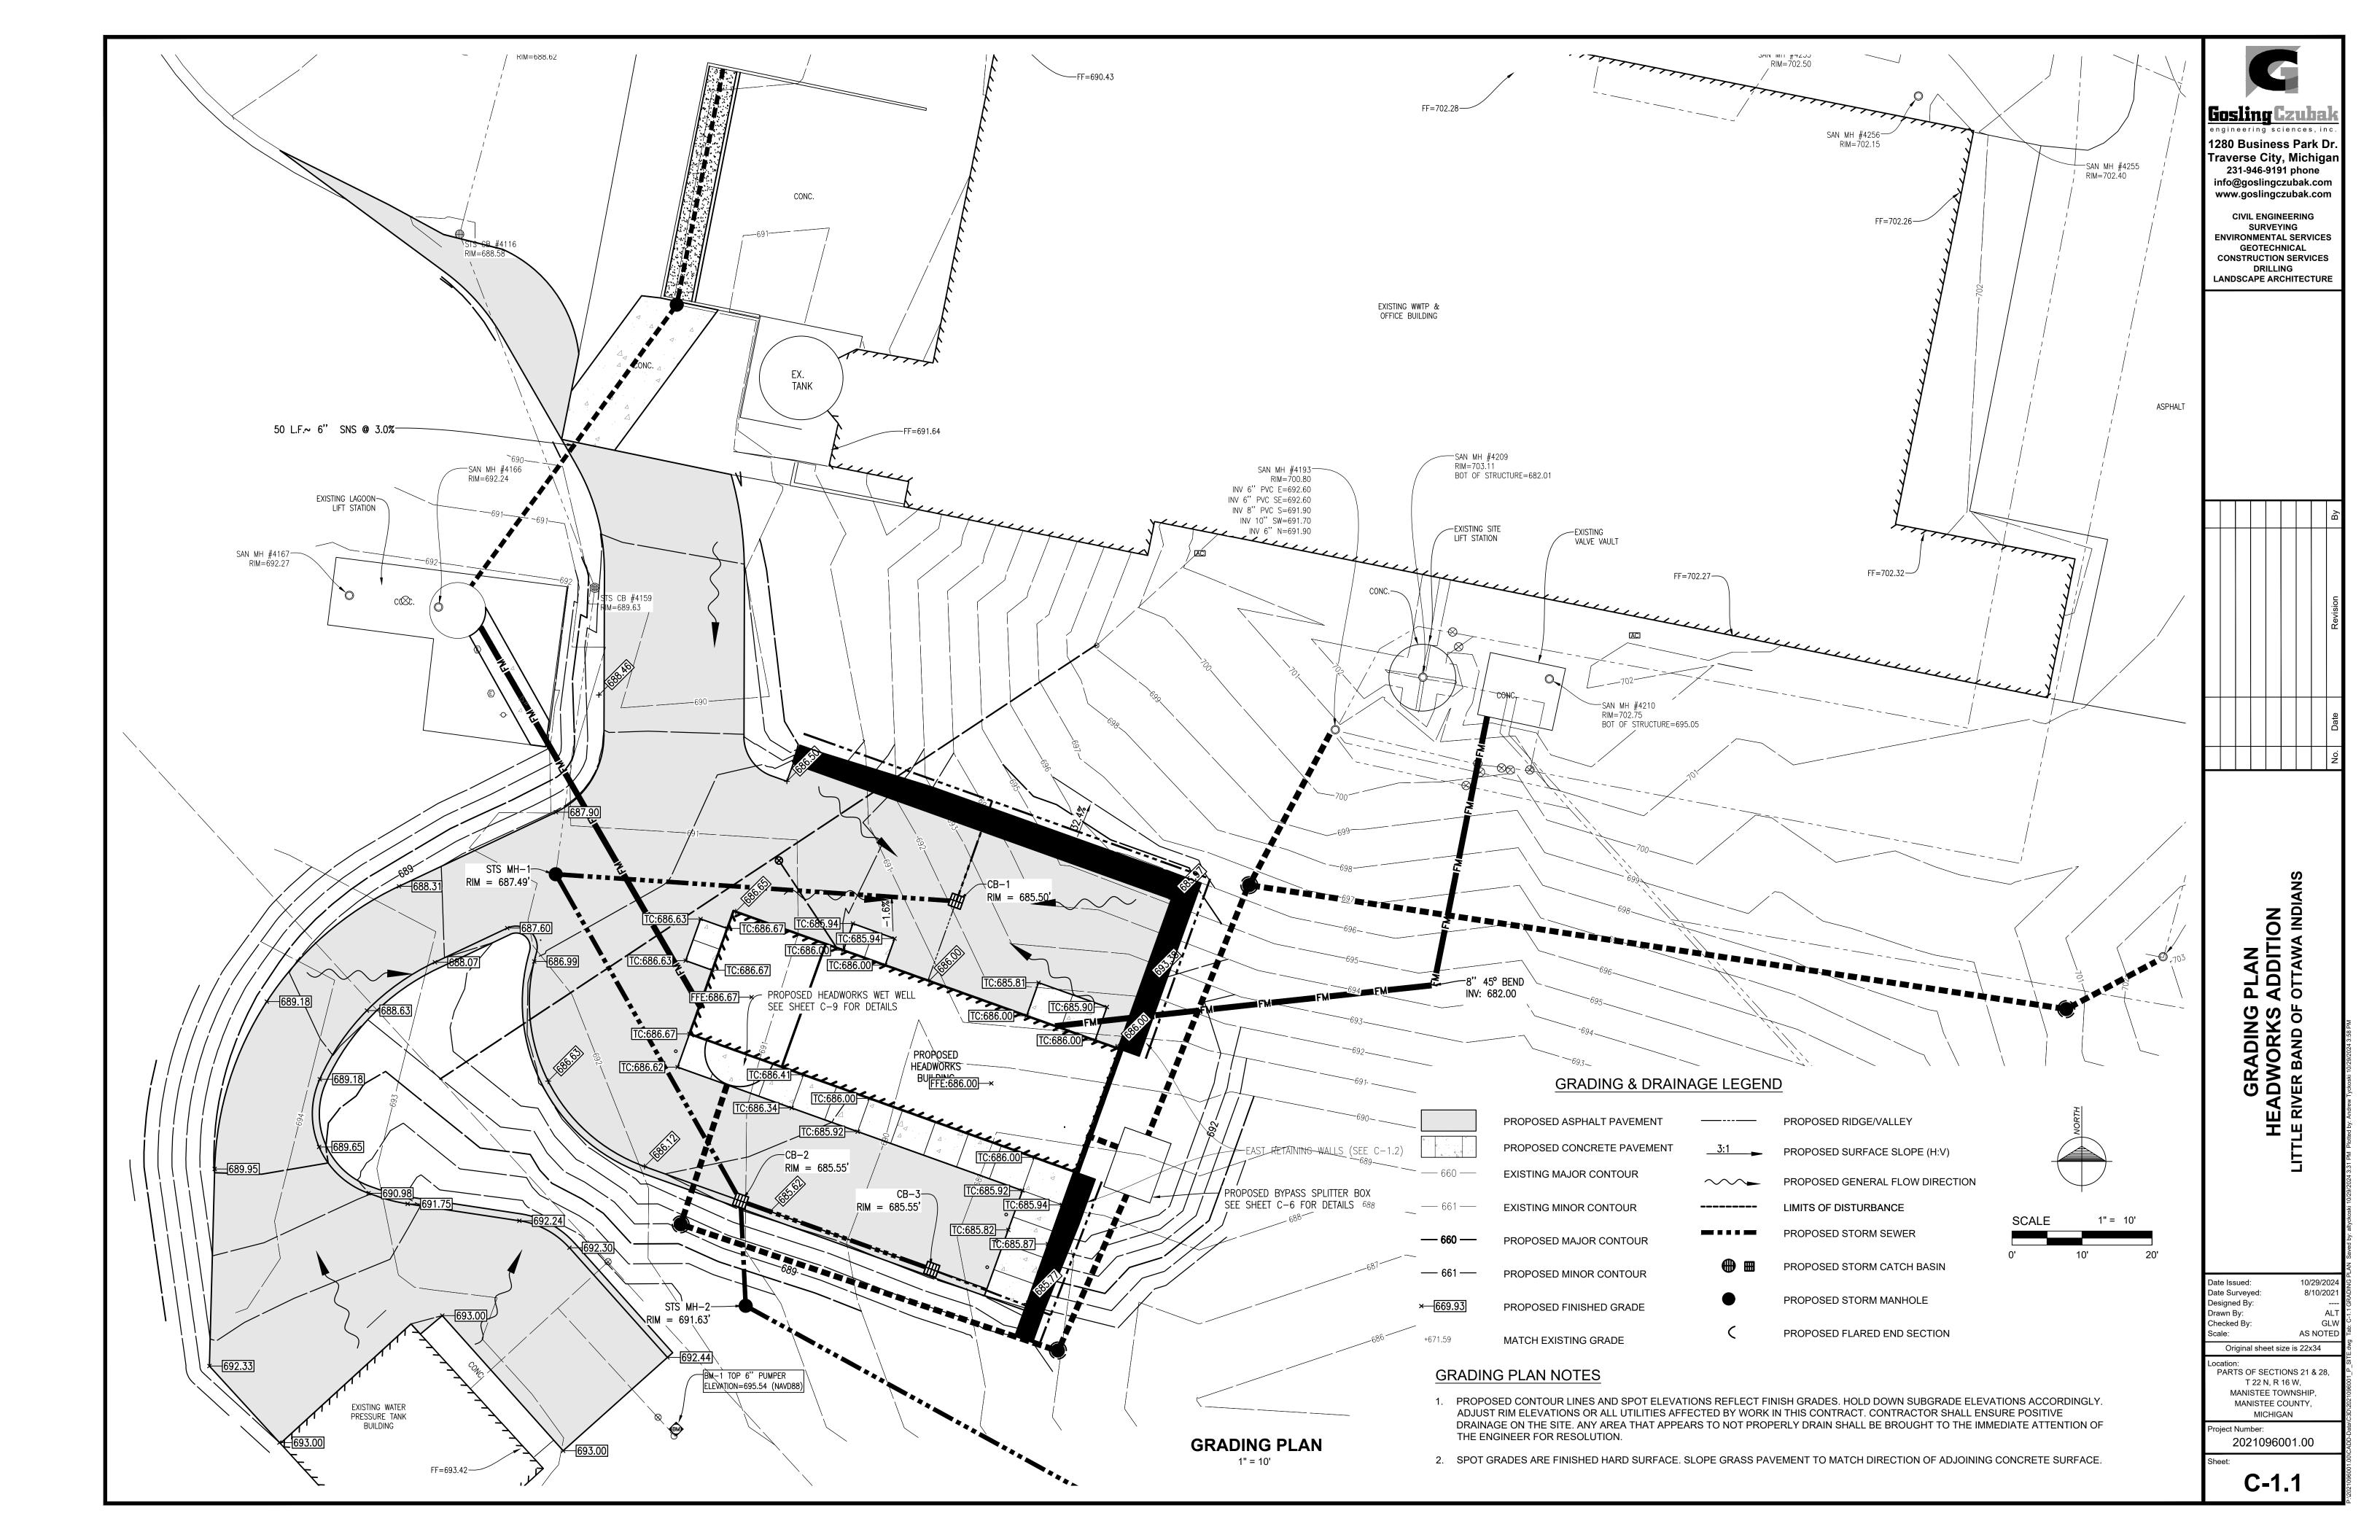

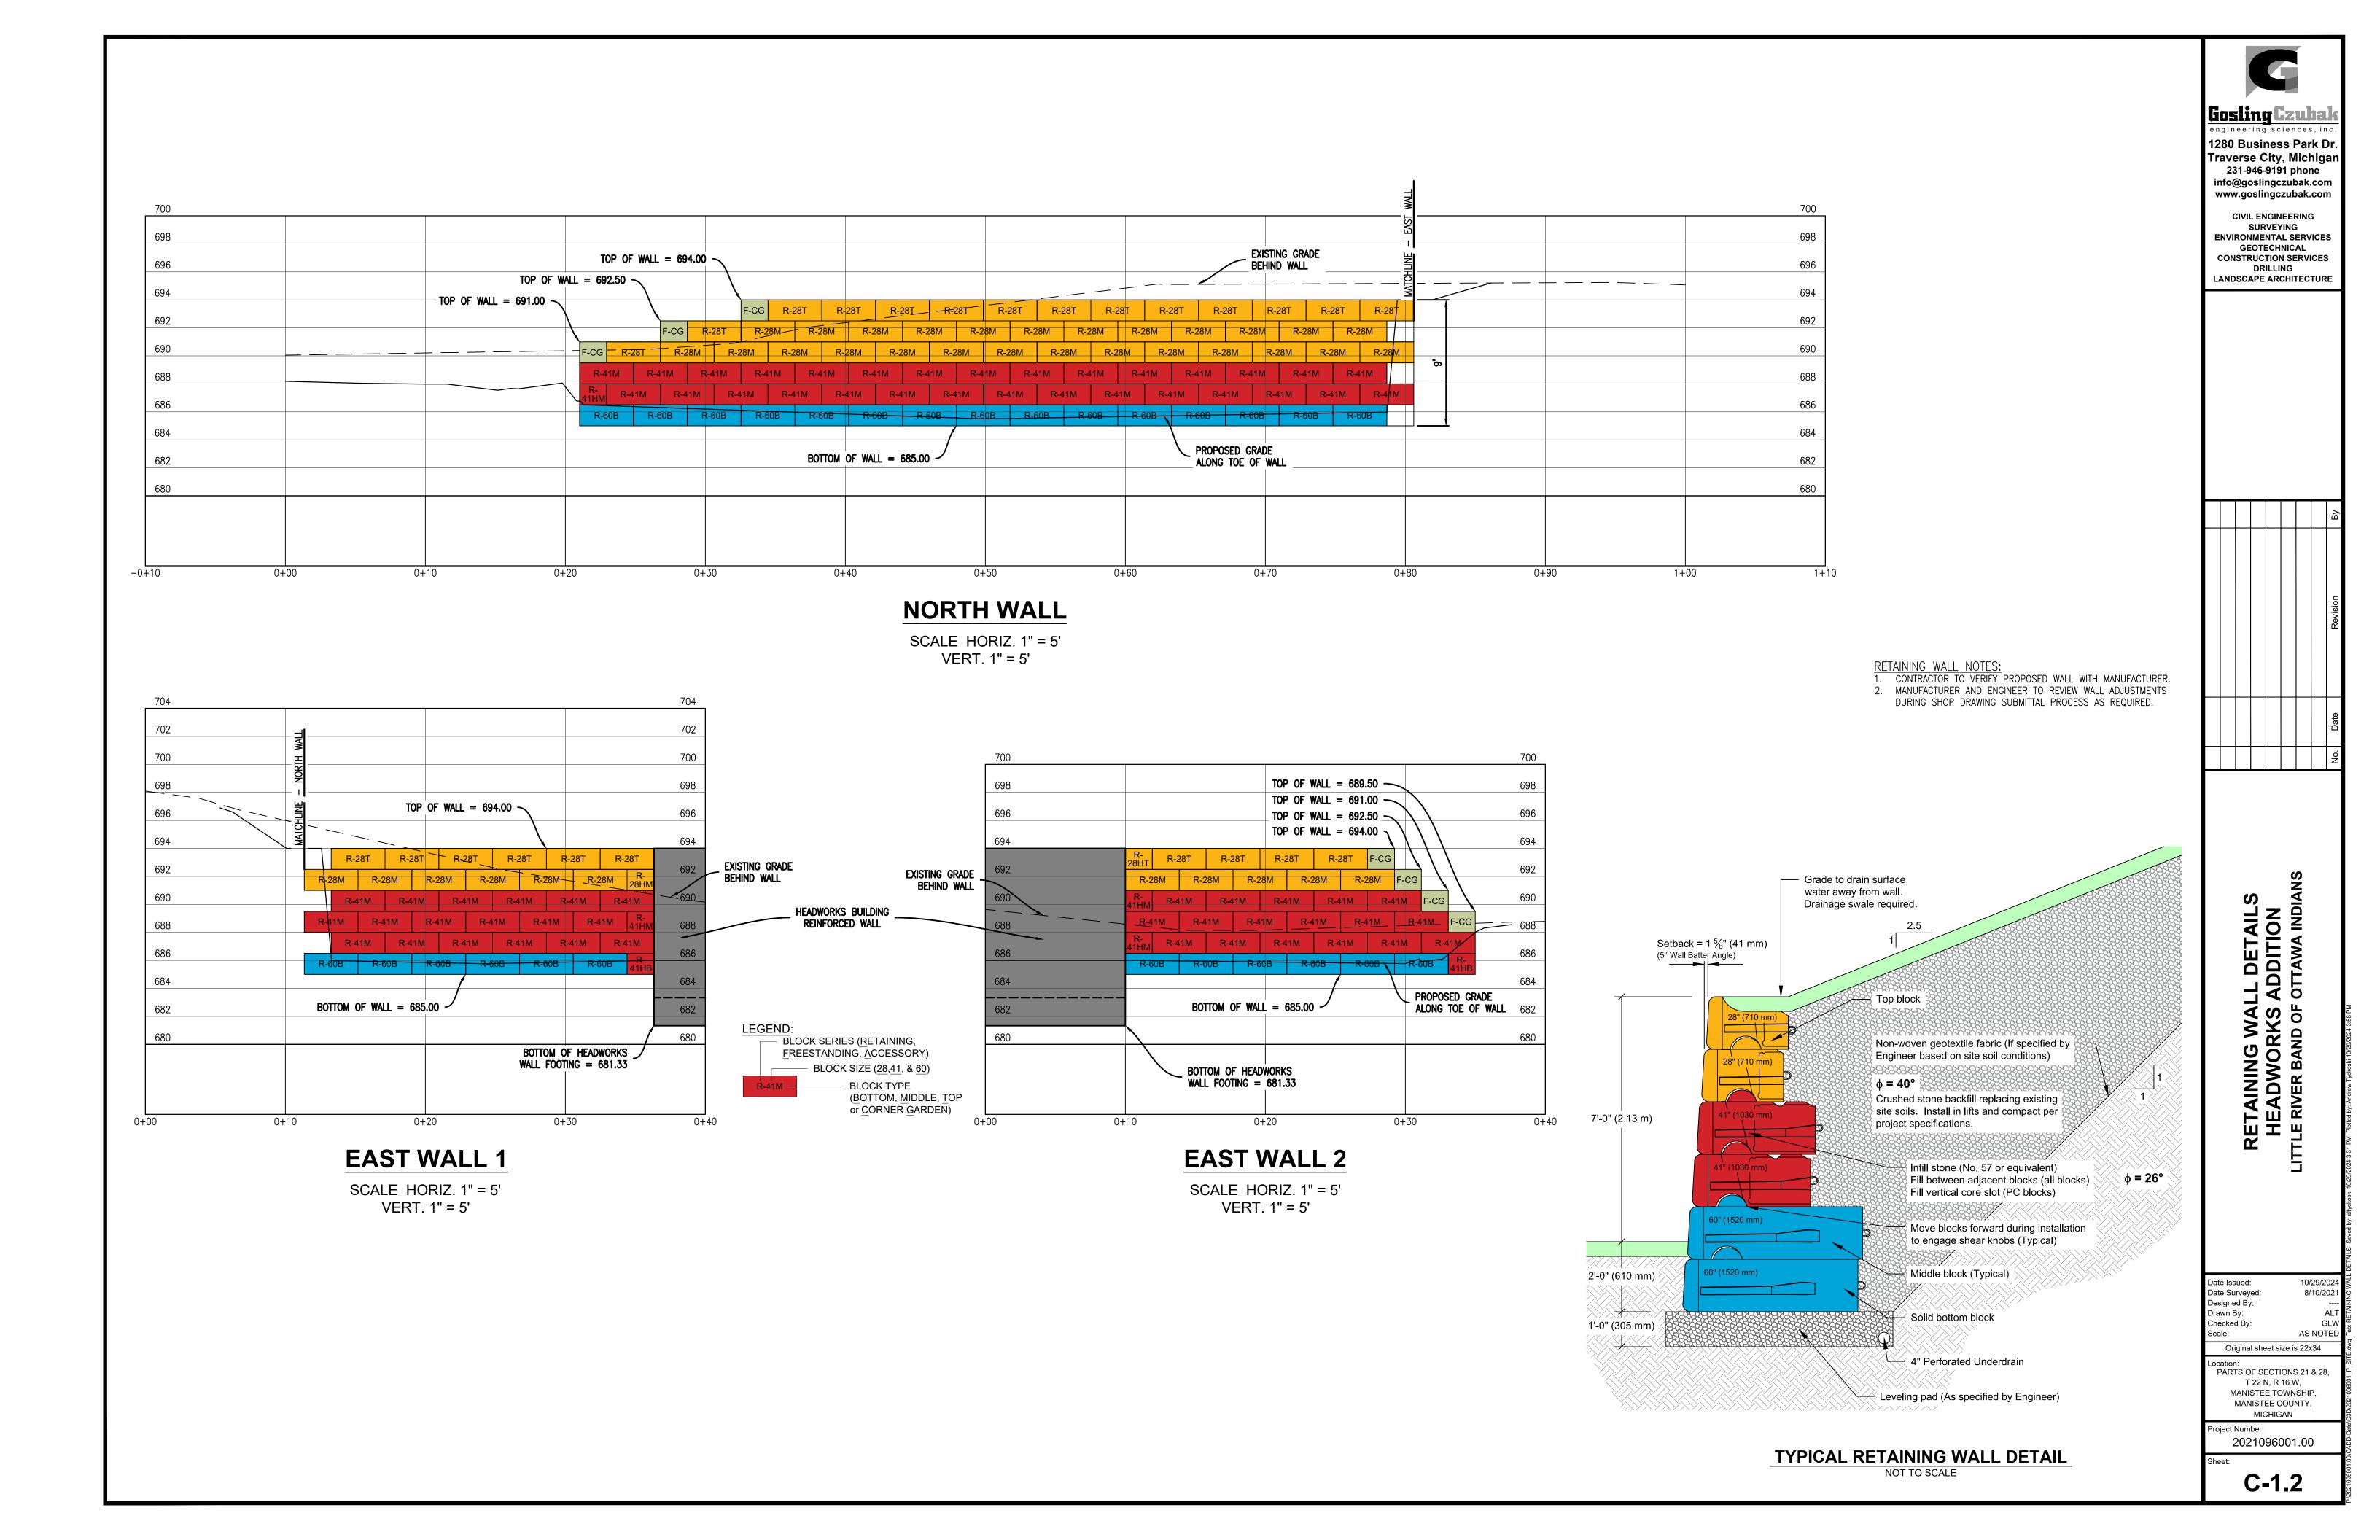

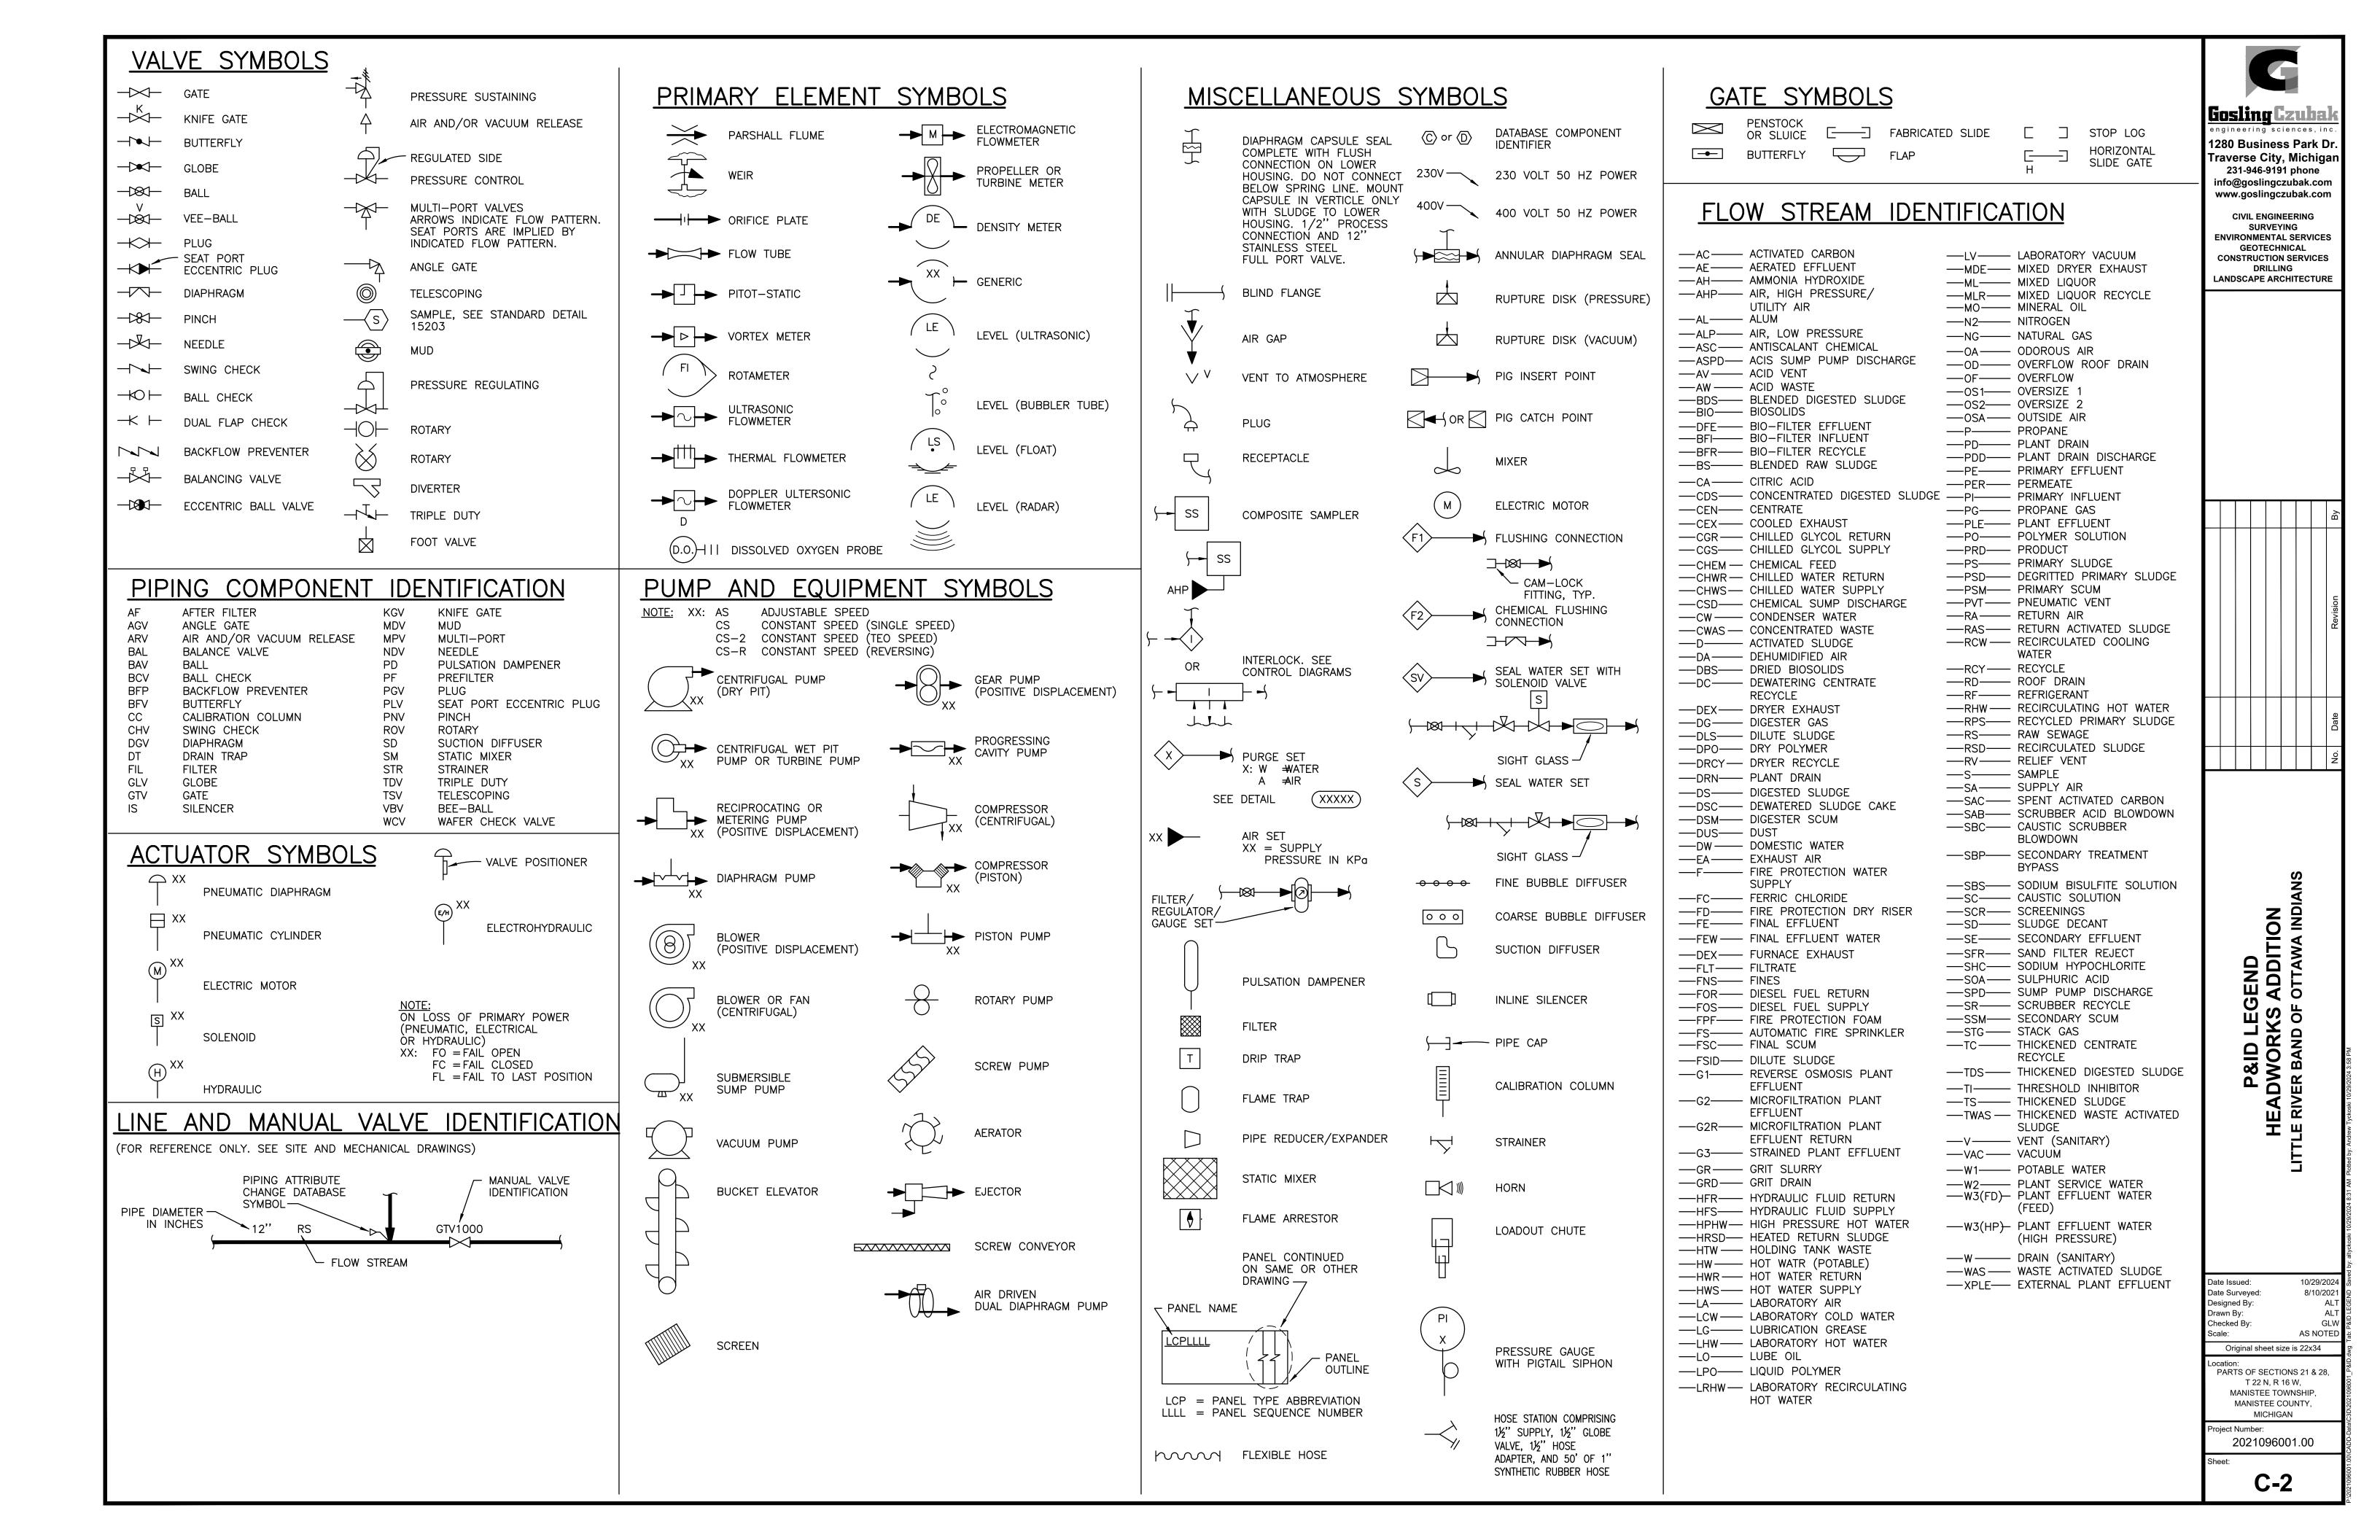

#### INSTRUMENT IDENTIFICATION EXAMPLE SYMBOLS FIRST-LETTER SUCCEEDING-LETTERS PROCESS OR READOUT OR LETTER INITIATING VARIABLE MODIFIER PASSIVE FUNCTION OUTPUT FUNCTION MODIFIER A ANALYSIS (+) ALARM FIRST LETTER(S) B BURNER COMBUSTION USER'S CHOICE (\*) USER'S CHOICE (\*) USER'S CHOICE (\*) SUCCEEDING LETTER(S) USER'S CHOICE (\*) CONTROL D DENSITY (S.G.) DIFFERENTIAL - CLARIFYING ABBREVIATIONS VOLTAGE PRIMARY ELEMENT (SENSOR) FIT F FLOW RATE (FRACTION) ARE MULTIPLE DEVICES WITH THE G USER'S CHOICE (\*) CLASS, GAUGE GATE SAME SEQUENTIAL LOOP NUMBER) VIEWING DEVICE HIGH H HAND (MANUAL) I CURRENT (ELECTRICAL) INDICATE J POWER TRAIN NUMBER (USED WHEN THERE K TIME, TIME SCHEDULE TIME RATE OF CONTROL STATION ARE PARALLEL TRAINS) SEQUENTIAL LOOP NUMBER L LEVEL LIGHT (PILOT) LOW FACILITY NUMBER M MOTION MIDDLE MOMENTARY N TORQUE USER'S CHOICE (\*) USER'S CHOICE (\*) USER'S CHOICE (\*) O USER'S CHOICE (\*) ORIFICE, RESTRICTION PRESSURE, VACUUM Q QUANTITY INTEGRATE, R RADIATION RECORD OR PRINT S SPEED, FREQUENCY SAFETY SWITCH T TEMPERATURE **TRANSMIT** U MULTIVARIABLE MULTIFUNCTION MULTIFUNCTION MULTIFUNCTION VALVE, DAMPER, LOUVER VIBRATION, MECHANICAL W WEIGHT, FORCE WFII X UNCLASSIFIED (+) UNCLASSIFIED (+) UNCLASSIFIED (+) X AXIS UNCLASSIFIED (+) Y EVENT, STATE OR RELAY, COMPUTE, Z POSITION, DIMENSION Z AXIS DRIVE, ACTUATOR, UNCLASSIFIED FINAL CONTROL ELEMENT (+) WHEN USED, EXPLANATION IS SHOWN ADJACENT TO INSTRUMENT SYMBOL. SEE ABBREVIATIONS AND LETTER SYMBOLS. (\*) WHEN USED, DEFINE THE MEANING HERE FOR THE PROJECT BENERAL INSTRUMENT OR FUNCTION SYMBOLS ON CENTRAL BEHIND IN THE ON LOCAL CONTROL CONTROL FIELD CONTROL PANEL PANEL PANEL (OR MCC) DISCRETE INSTRUMENT SHARED CONTROL/DISPLAY le.g., DCS) COMPUTER FUNCTION PROGRAMMABLE LOGIC CONTROLLER SPECIAL CASES ACCESSORY DEVICES (DATABASE SYMBOLS) ON AND OFF EVENT LIGHTS **EXAMPLE:** TRANSMITTER AS AN ACCESSORY TO A FLOW ELEMENT /ALARM ON-OFF-HAND SWITCH MAINTAINED CONTACT SWITCH ´HS ` CONTROLLER (CONTROLLED DEVICE WILL RESTART ON RETURN OF INDICATOR POWER AFTER POWER FAILURE). | = RECORDER SWITCH TRANSMITTER STOP-START HAND SWITCH MOMENTARY CONTACT SWITCHES / HS $\setminus$ (CONTROLLED DEVICE WILL NOT RESTART ON RETURN X = UNCLASSIFIEDFBD = FINE BUBBLE DIFFUSER OF POWER AFTER POWER FAILURE). GBC = GRAVITY BELT CONCENTRATOR HPU = HYDRAULIC POWER UNIT TRANSDUCERS DIGITAL SYSTEM INTERFACES ANALOG CURRENT ANALOG INPUT DIGITAL PNEUMATIC ANALOG OUTPUT VOLTAGE PULSE FREQUENCY DISCRETE INPUT Δ PULSE DURATION **FREQUENCY** DISCRETE OUTPUT $\nabla$ **HYDRAULIC RESISTANCE**

CURRENT TO PNEUMATIC

TRANSDUCER (BACK OF

PANEL, IN A FLOW LOOP)

FY

# LINE LEGEND ANALOG SIGNAL (4 TO 20 mADC, ETC.) PARALLELING LINES DISCRETE SIGNAL - + - + -(ON/OFF, ETC.) $\lfloor -(2) \rfloor - 3(2)$ <del>──//──//</del> PNEUMATIC SIGNAL (A) TOTAL OF 2 SIGNALS (B) 3 TYPICAL SETS OF 2 SIGNALS EACH. <del>LLL</del> HYDRAULIC SYSTEM SIGNAL TOTAL OF 6 SIGNALS. ————— DATA LINK CONNECTION LINES NON-CONNECTING NEW PRIMARY PROCESS TYPICAL BOUNDARY SECONDARY PROCESS (WATER SERVICES, **EXISTING** CHEMICALS, ETC.) EQUIPMENT & PRIMARY, SECONDARY PROCESSES & EQUIPMENT LOS INSTRUMENT CONTINUATION SYMBOLS S $N \longrightarrow$ <u>}</u> --**>**( N ) PROCESS CONTINUATION SIGNAL CONTINUATION = CONTINUATION NO. = DESTINATION DRAWING NO. = SOURCE DRAWING NO. PROCESS OR SIGNAL LINE $N - - - \rightarrow$ CONTINUATION N=1,2,3,ETCCONTINUATION TO OR FROM EXISTING PROCESS **EQUIPMENT TAG NUMBERS** AC = AIR COOLER\*DLLLL AD = AIR DRYERAR = AIR RECEIVERARV = AIR RELEASE VALVE \*SEE GENERAL NOTE 4 AHU = AIR HANDLING UNIT AVRV = AIR AND VACUUM RELEASE VALVE B = BLOWERC = COMPRESSORCBBD = COUNTER BALANCED BACK DRAFT DAMPER CBD = COARSE BUBBLE DIFFUSER E = EJECTOR

ED = EDUCTOR

F = FAN

G = GATE

HTR = HEATER

NETWORK CONNECTION

SEE NETWORK DIAGRAMS.

FOR ADDITIONAL INFORMATION,

EF = EXHAUST FAN

M = MECHANICAL EQUIPMENT

# GENERAL NOTES

. COMPONENTS AND PANELS SHOWN WITH A SINGLE ASTERISK ( st ) ARE TO BE PROVIDED AS PART OF A PACKAGE SYSTEM.

ABBREVIATIONS & LETTER SYMBOLS

OC

OCR

OCA

00

OOA

ORP

RM

SF

SS

SSC

TCL<sub>2</sub>

TOC

TOD

TURB

VFD

VHC

RTU

OPEN-CLOSE (D)

ON-OFF-AUTO

ON-OFF-REMOTE

OPEN-STOP-CLOSE

PURGE CONNECTION

REMOTE I/O UNIT

SLOWER-FASTER

START-STOP

**TURGIDITY** 

**VIBRATION** 

**MULTIPLY** 

DIVIDE

**AVERAGE** 

BIAS

SUM

DIFFERENCE

CHARACTERIZED

SQUARE ROOT

REPEAT OR BOOST

GAIN OR ATTENUATE

SELECT HIGHEST SIGNAL

SELECT LOWEST SIGNAL

ON-OFF

OPEN-CLOSE-REMOTE

OXIDATION REDUCTION POTENTIAL

OPEN-STOP-CLOSE-REMOTE

HYDROGEN ION CONCENTRATION

REMOTE MULTIPLEXING MODULE

REMOTE TELEMETRY UNIT

TOTAL CHLORINE RESIDUAL

VARIABLE FREQUENCY DRIVE

**VOLATILE HYDROCARBONS** 

RAISE TO THE Nth POWER

TOTAL ORGANIC CARBON

TOTAL OXYGEN DEMAND

PROGRAMMABLE LOGIC CONTROLLER

SUPERVISORY SET POINT CONTROL

OPEN-CLOSE-AUTO

ALTERNATING CURRENT

COMPUTER-AUTO-MANUAL

ADJUSTABLE SPEED DRIVE

CENTRAL CONTROL SYSTEM

CHEMICAL OXYGEN DEMAND

DISTRIBUTED CONTROL SYSTEM

DISTRIBUTED CONTROL UNIT

DIRECT DIGITAL CONTROLLER

FREE CHLORINE RESIDUAL

FIELD NETWORK INTERFACE

FAST-OFF-SLOW-AUTO

FORWARD-REVERSE

HAND-OFF-REMOTE

HAND-OFF-AUTO

LOCKOUT STOP

LOCAL-REMOTE

MANUAL-AUTO

MODULATE-CLOSE

AREA BASED NUMBERING

PRT = PRINTER

SVR = SERVER

VP = VIDEO PROJECTOR

WS = WORKSTATION

**IAACCNNNNS WHERE:** 

FAST-OFF-SLOW-REMOTE

INTRINSICALLY SAFE RELAY

LOCAL CONTROL STATION

LOCAL CONTROL PANEL

LOWER EXPLOSIVE LIMIT

MOTOR CONTROL CENTER

MANUFACTURER SUPPLIED CABLE

I = INSTRUMENTATION ITEM

CC = COMPONENT ABBREVIATION:

DDC = DIRECT DIGITAL CONTROLLER

AA = PLANT AREA/FACILITY NUMBER

NNNN = SEQUENTIAL EQUIPMENT NUMBER

S = OPTIONAL SUFFIX LETTER

PLC = PROGRAMMABLE LOGIC CONTROLLER

AUTO-MANUAL

CL2 etc. CHLORINE (TYPICAL: USE

STANDARD CHEMICAL

COMPUTER-MANUAL

DIRECT CURRENT

DISSOLVED OXYGEN

FAST-PFF-SLOW

FIELD PANEL

E-STOP EMERGENCY STOP

**ELEMENT ABBREVIATION** 

CONTROL PANEL NO. X

 $\mathsf{AM}$ 

CAM

ASD

CCS

CM

COD

CP

DC

DCS

DCU

DDC

DO

FCL<sub>2</sub>

FNI

FOS

**FOSA** 

**FOSR** 

FΡ

FR

HOA

HOR

ISR

LCS

LCP

LEL

LR

MA

MC

MCC

MSC

D

MD = MOTORIZED DAMPER

SL = STATIONARY LOUVER

LLLL = SEQUENTIAL LOOP NUMBER

P = PUMP

T = TANK

S = STRAINER

SF = SUPPLY FAN

SA = SAMPLER

- 2. COMPONENTS AND PANELS SHOWN WITH A DOUBLE ASTERISK ( \*\* ) ARE TO BE PROVIDED BY ELECTRICAL CONTRACTOR.
- 3. COMPONENTS SHOWN WITH A TRIPLE ASTERISK ( \*\*\* ) ARE TO BE PROVIDED BY MECHANICAL SUBCONTRACTOR(S) AND CONFORM TO SPEC. SECTION 15100 - PLUMBING PIPING.
- 4. THIS IS A STANDARD LEGEND. THEREFORE, NOT ALL OF THIS INFORMATION MAY BE USED ON THIS CONTRACT.
- 5. THE DIAMOND SYMBOL  $\langle C28 \rangle$  DENOTES MAJOR COMPONENTS OR SUBSYSTEMS TO BE SUPPLIED AND INSTALLED UNDER THE CONTRACT NUMBER SHOWN WITHIN THE DIAMOND. REFER TO THE CONTRACT DOCUMENTS FOR THE DETAILED SCOPE OF WORK RELATED TO SUPPLY, INSTALLATION, AND INTERFACING WITH OTHER CONTRACTORS.



1280 Business Park Dr Fraverse City, Michiga 231-946-9191 phone info@goslingczubak.com www.goslingczubak.com

CIVIL ENGINEERING SURVEYING **ENVIRONMENTAL SERVICES GEOTECHNICAL CONSTRUCTION SERVICES** DRILLING LANDSCAPE ARCHITECTURE

GEND S ADDITION F OTTAWA INDIA P&ID LEGAD DEGAD DEGAD NER BAND OF GAD DEGAD DEG EA RIV 로 백


Date Issued: 10/29/202 Date Surveyed: 8/10/2021 Designed By: Drawn By: Checked By: AS NOTED


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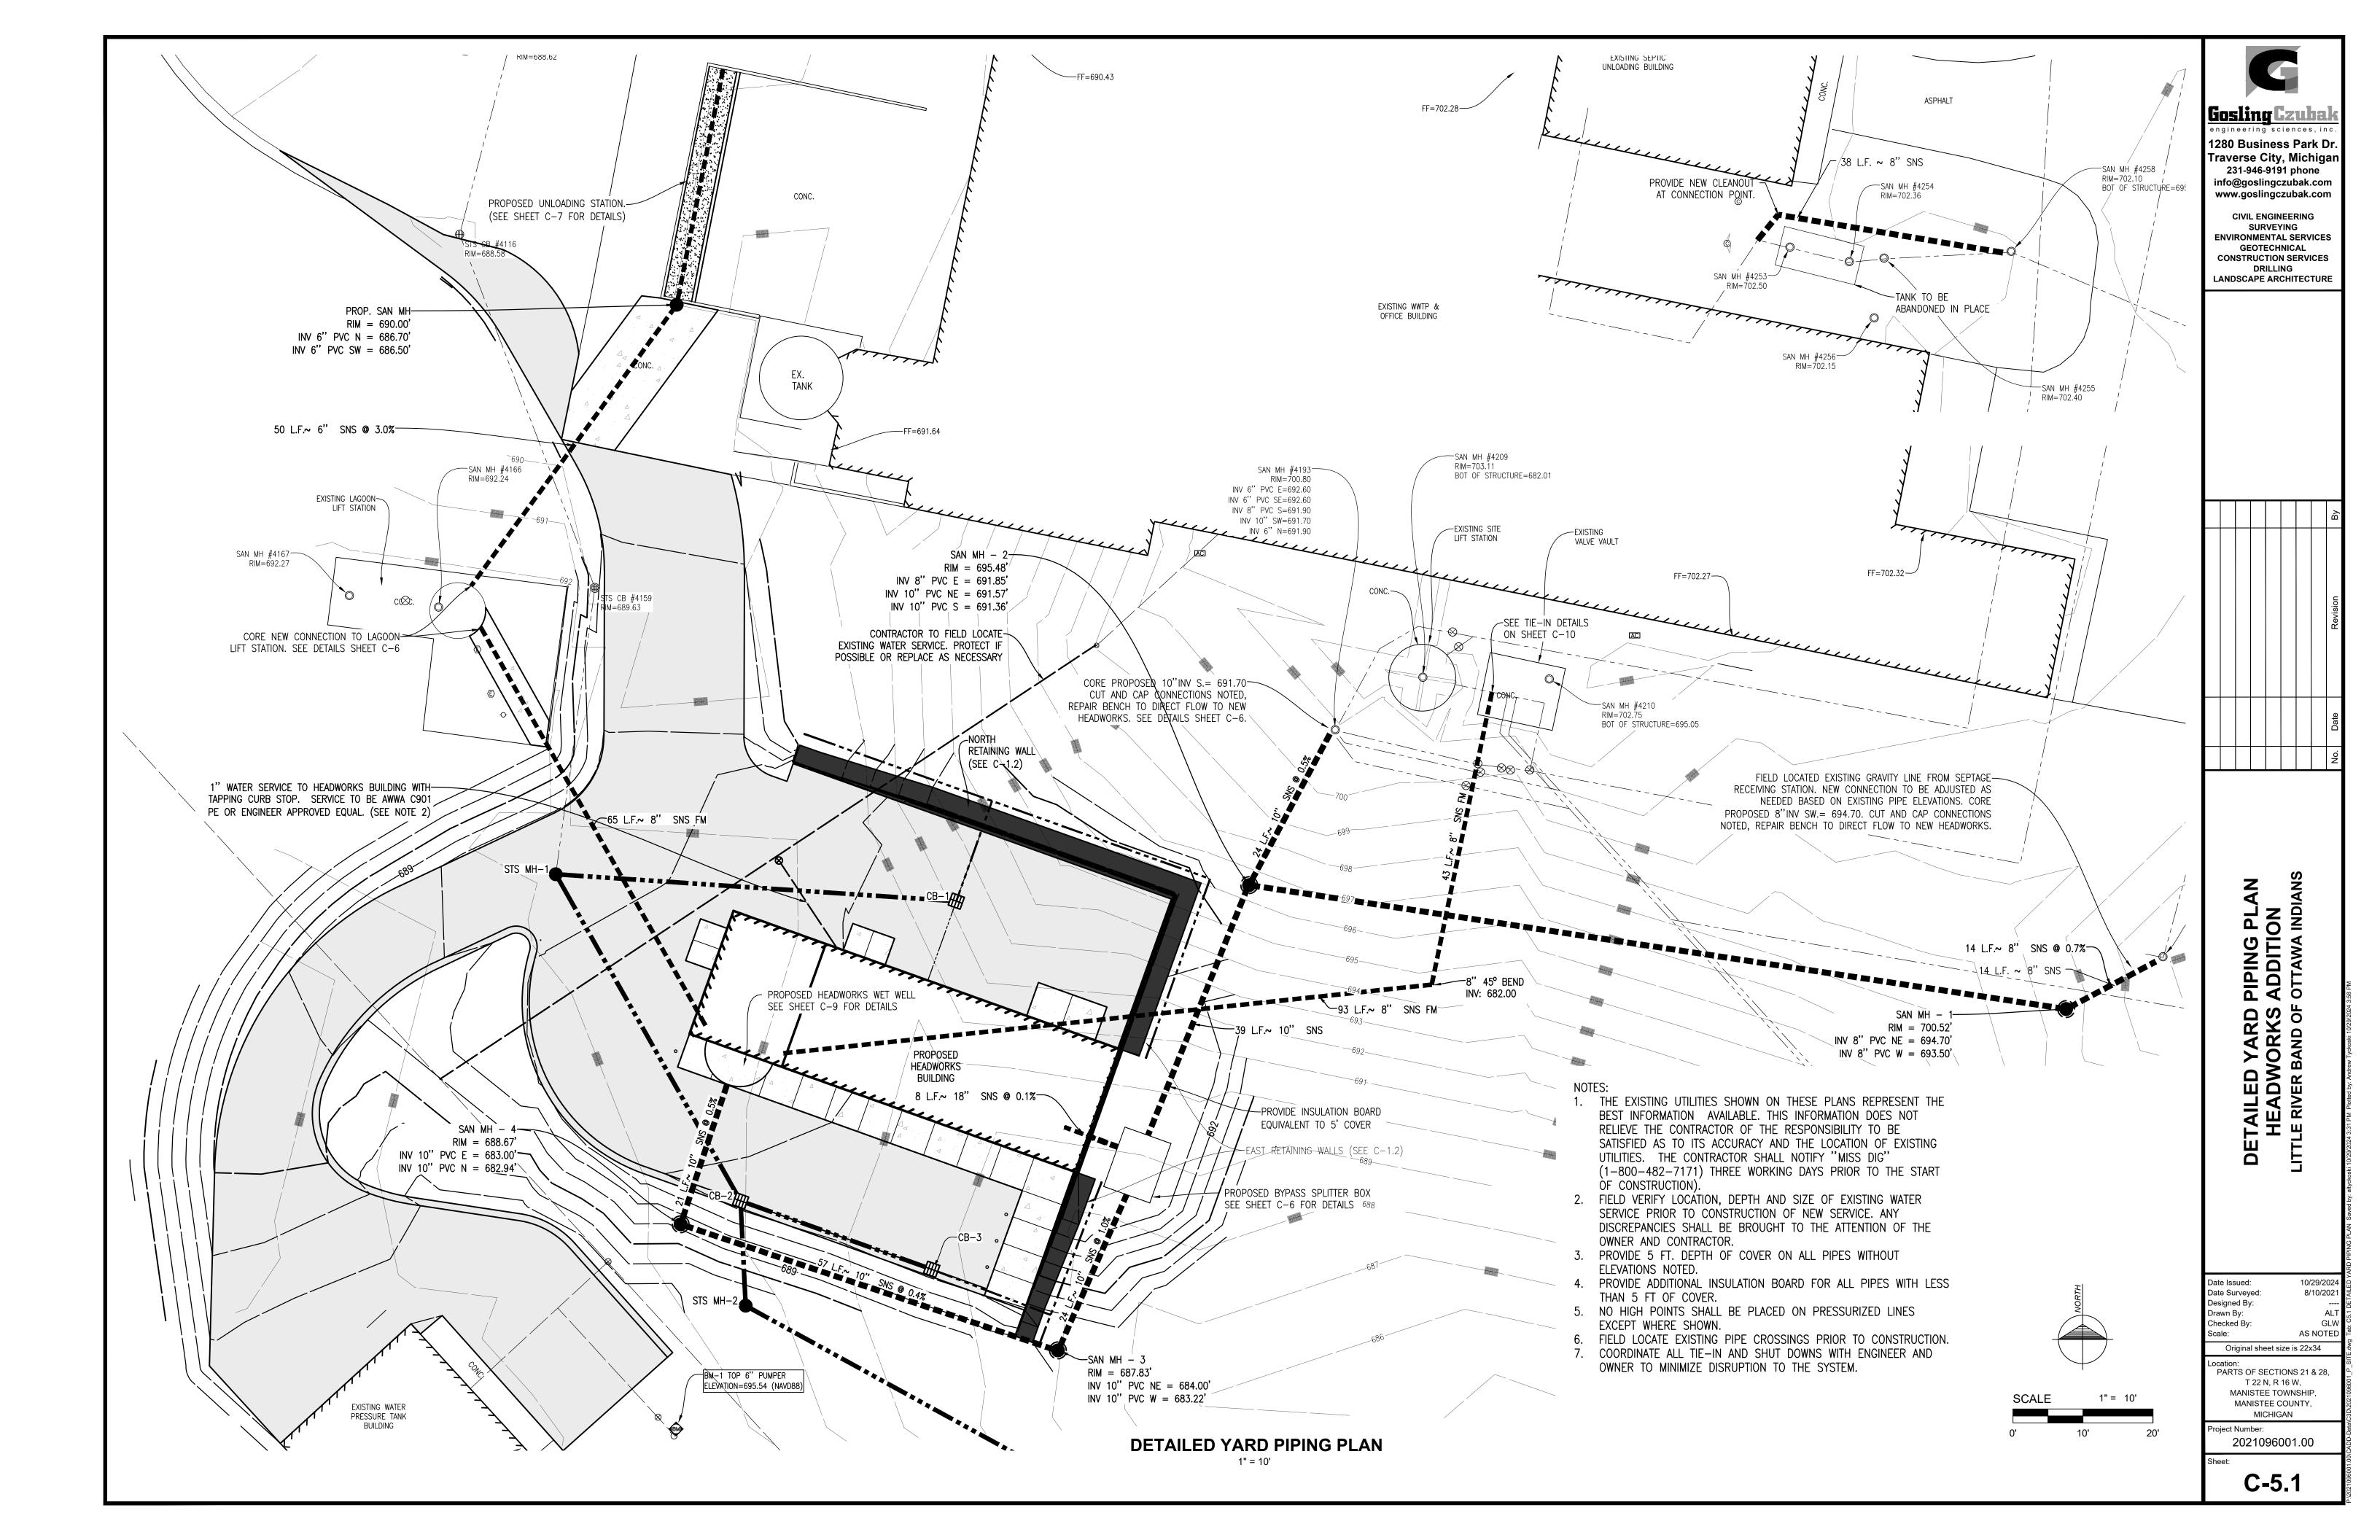
GLW


MANISTEE COUNTY, MICHIGAN


Project Number 2021096001.00




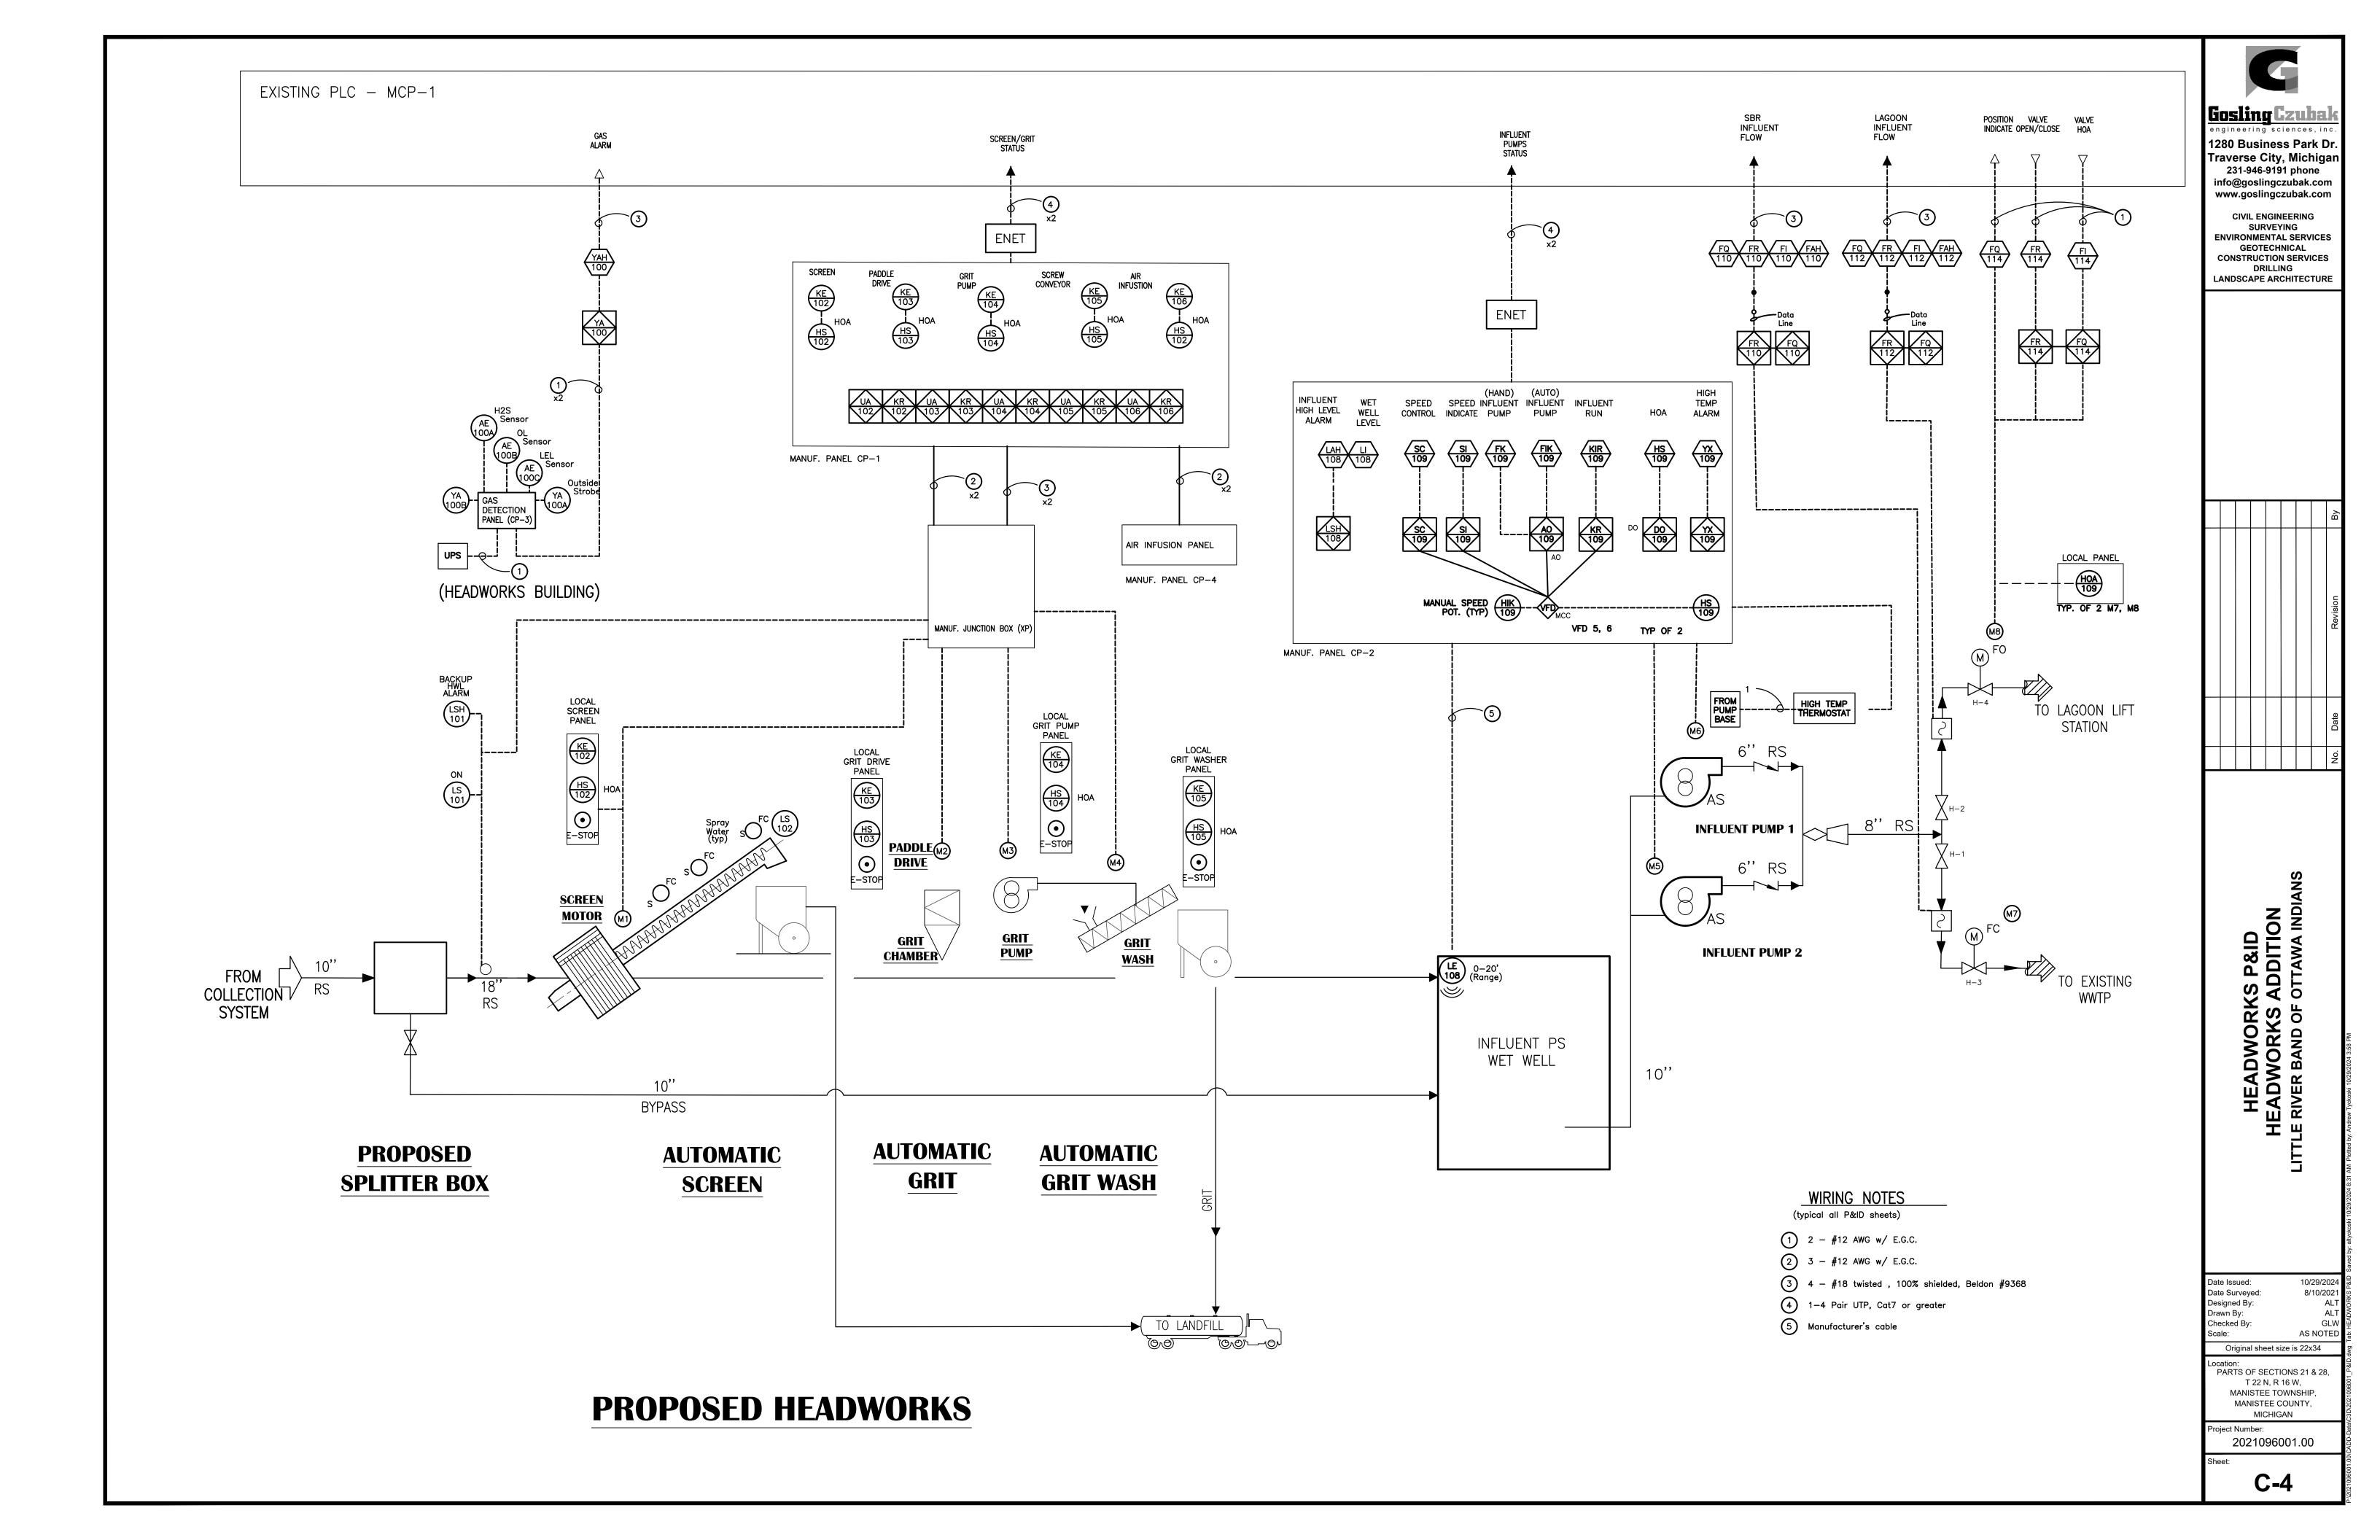


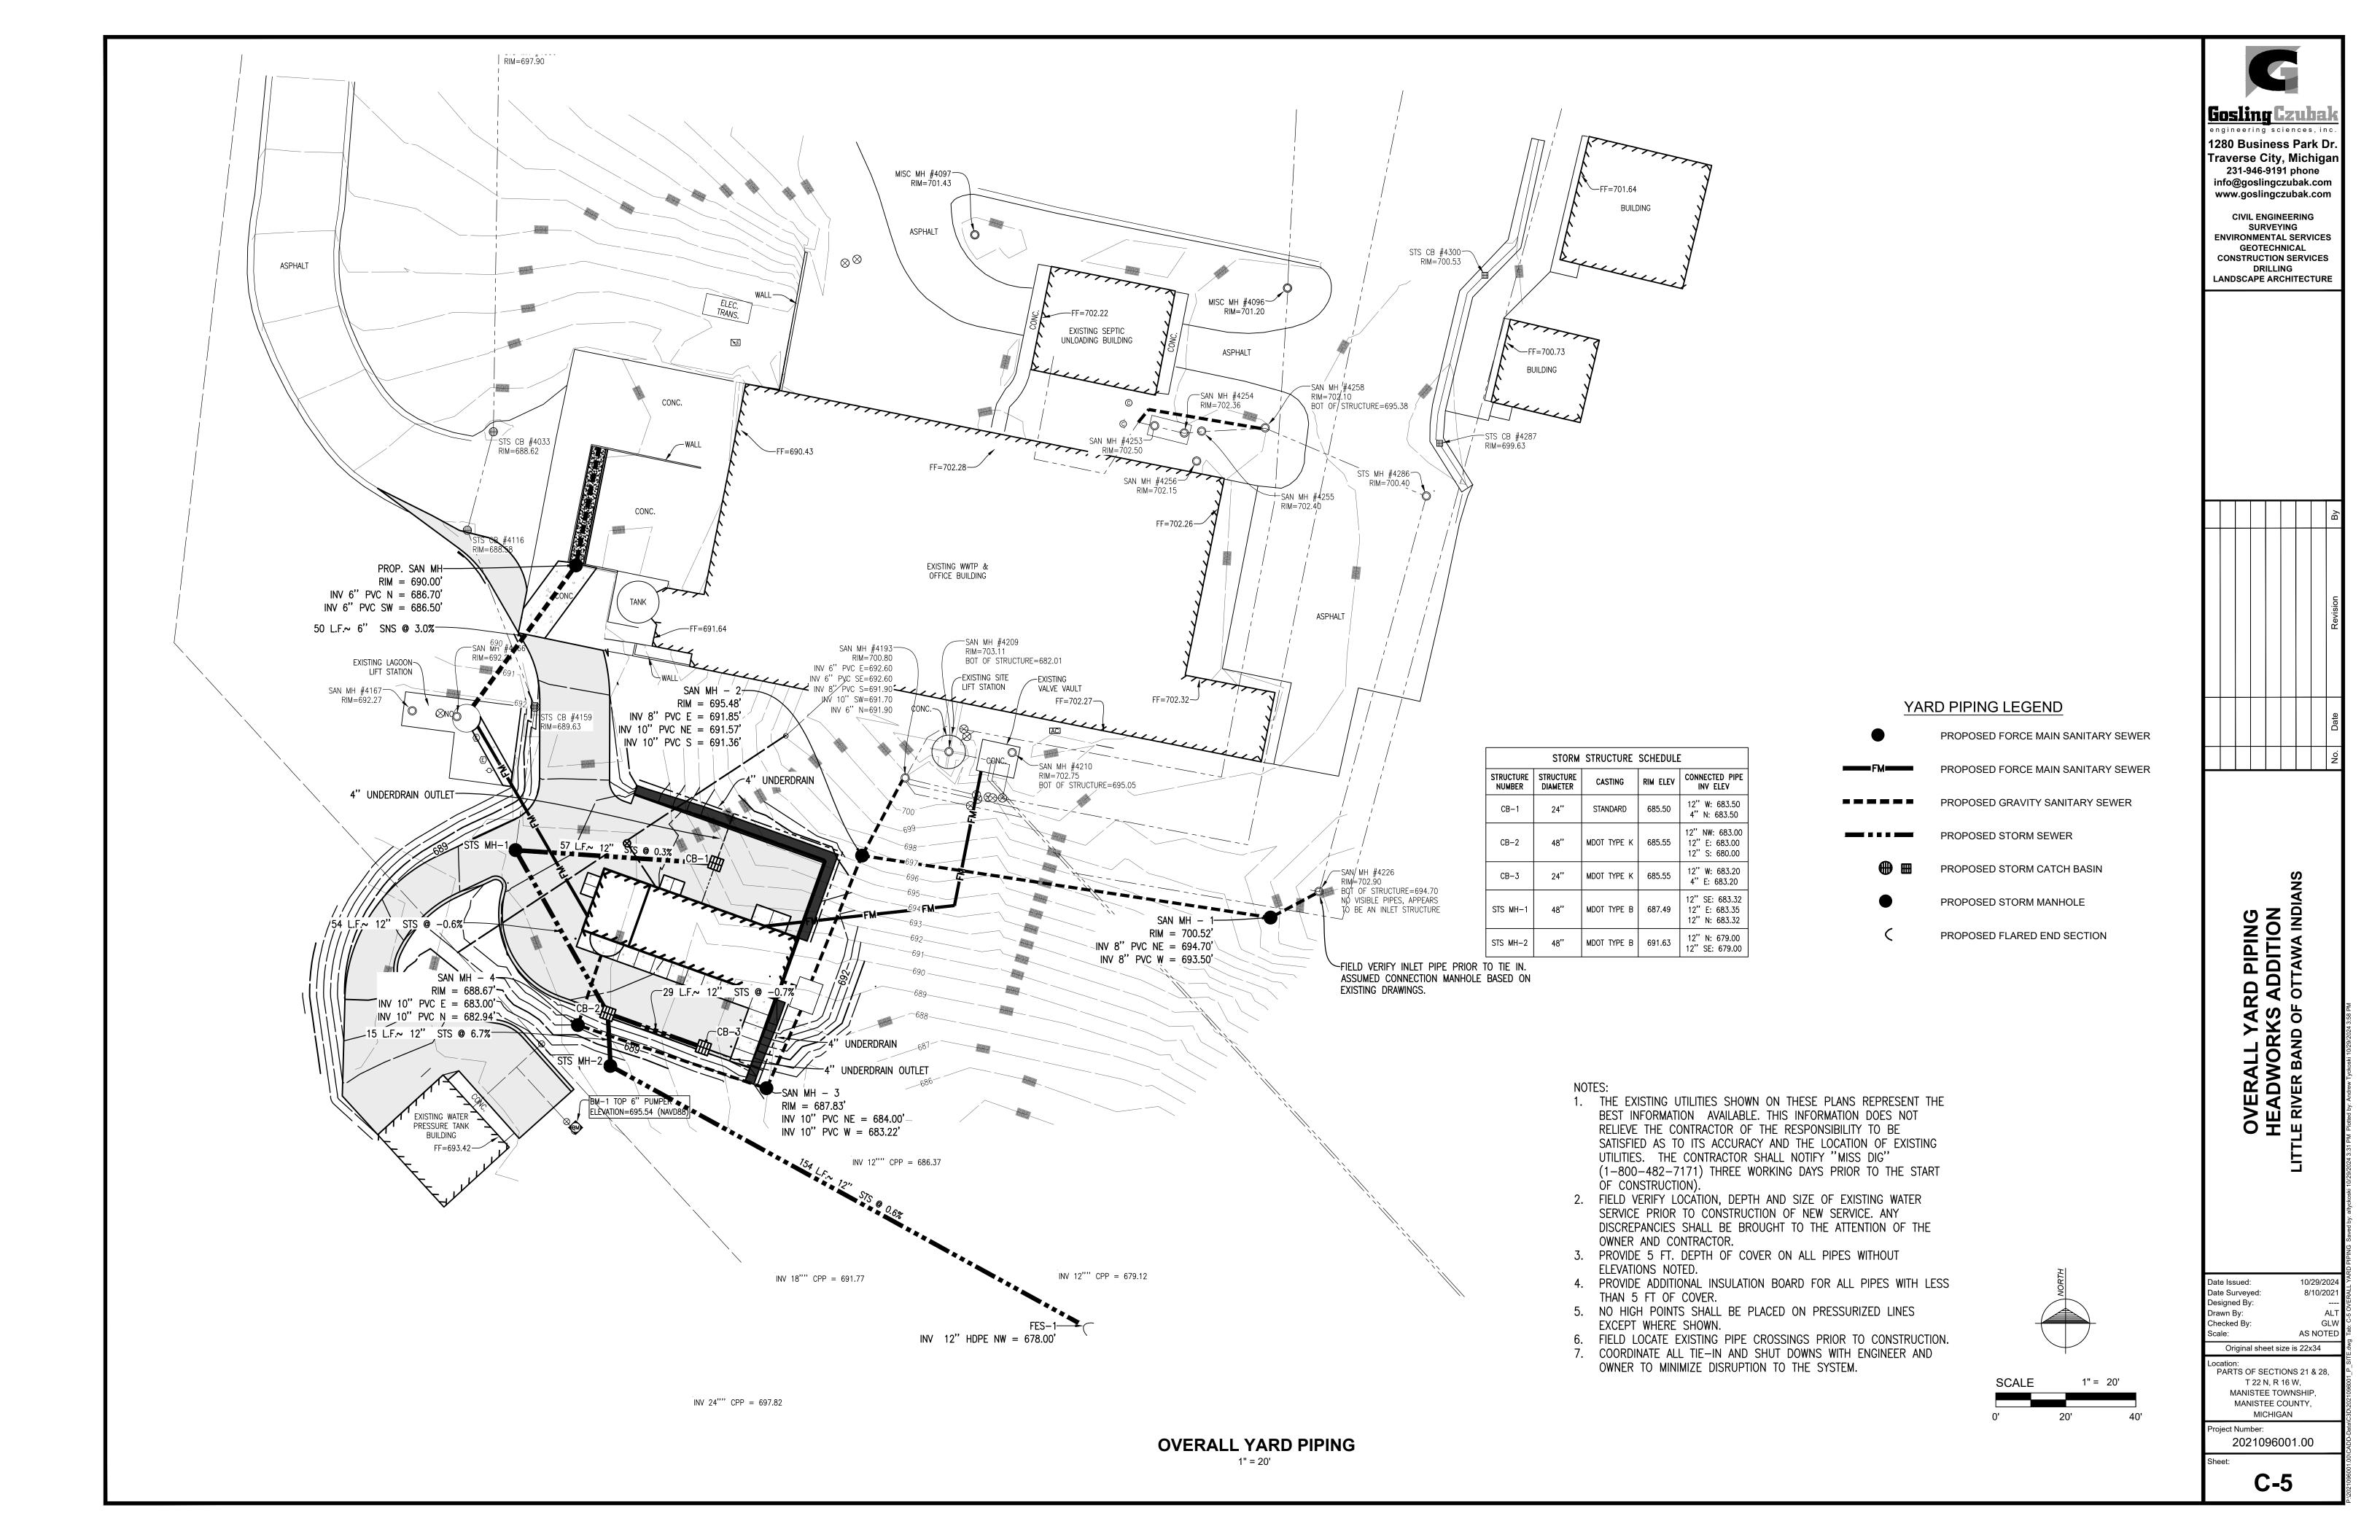

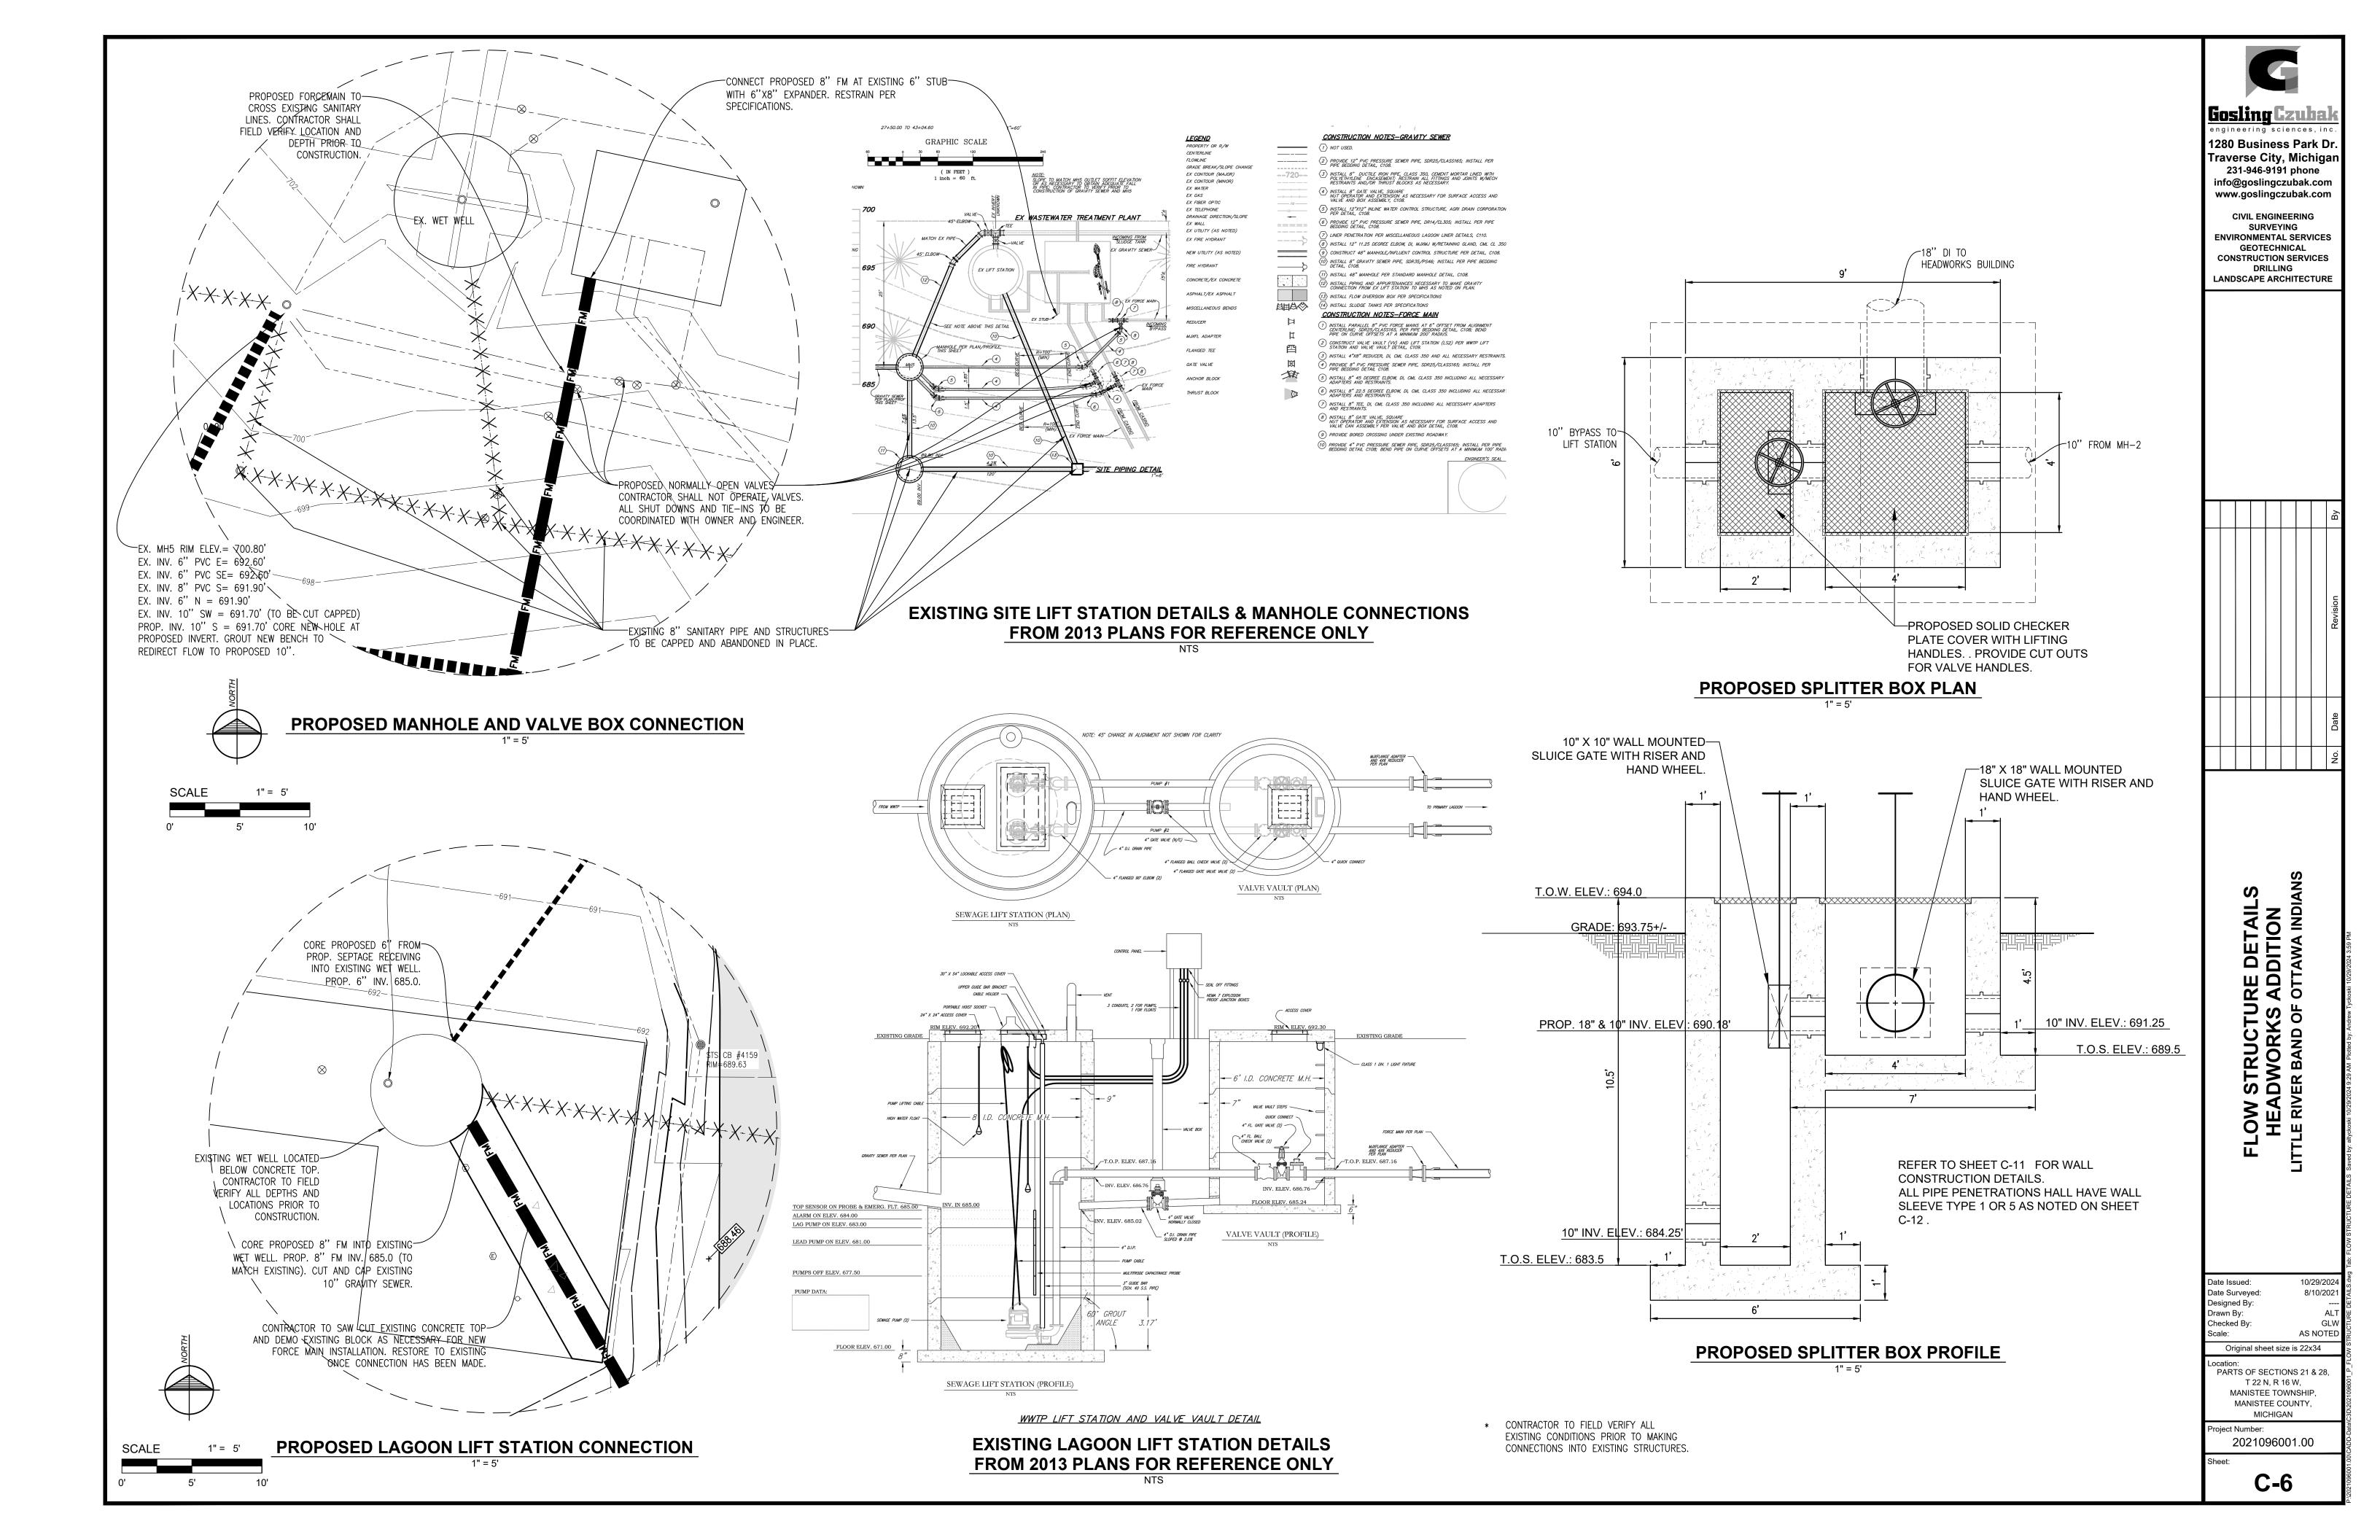

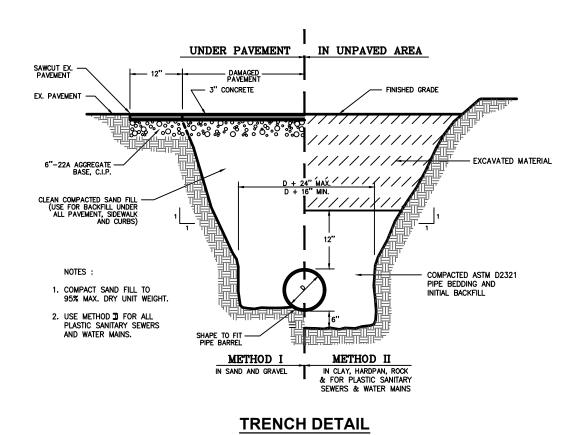


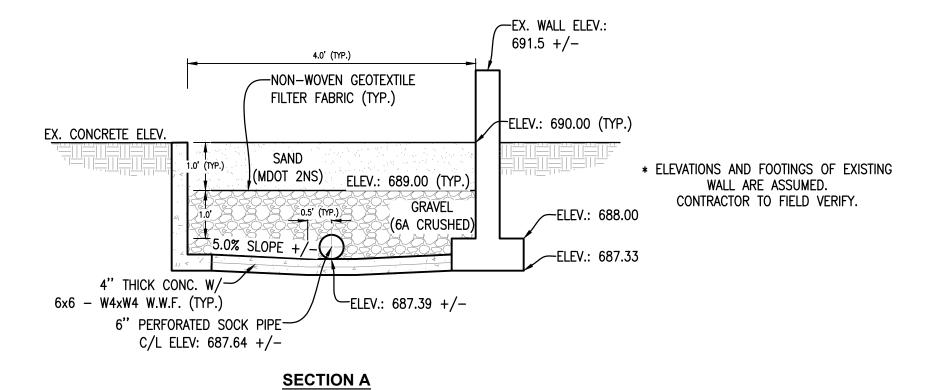

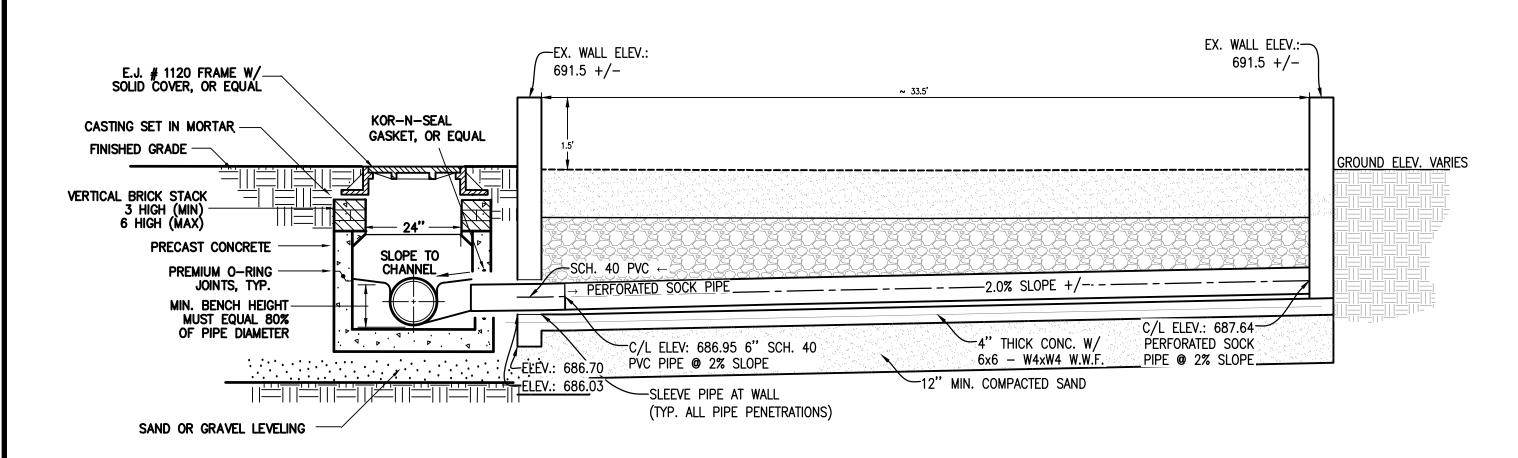

NOT TO SCALE


**SECTION B** 

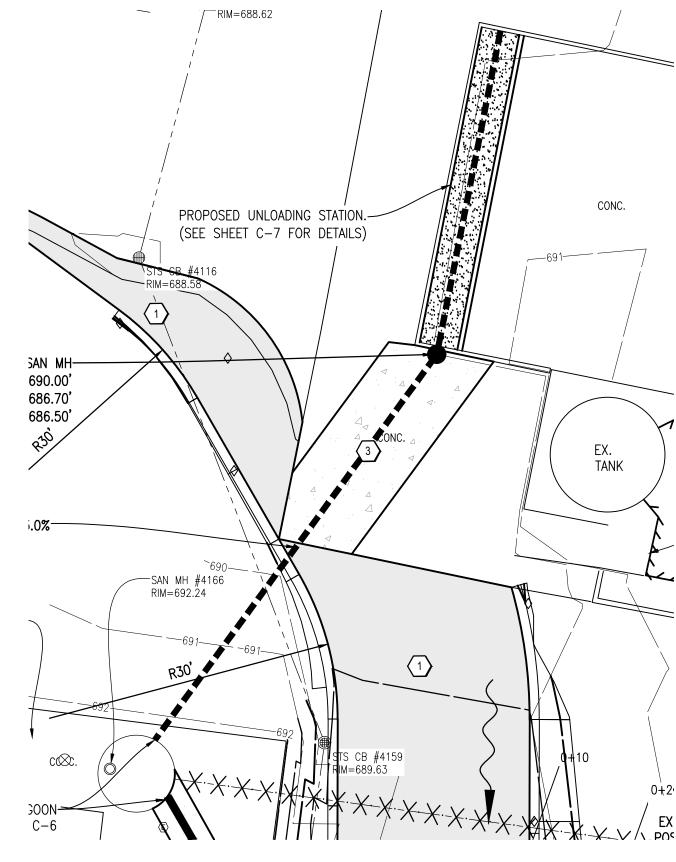

PROPOSED SEPTAGE UNLOADING SITE PLAN

SCALE: 1" = 10'

NOTE: 45° CHANGE IN ALIGNMENT NOT SHOWN FOR CLARITY

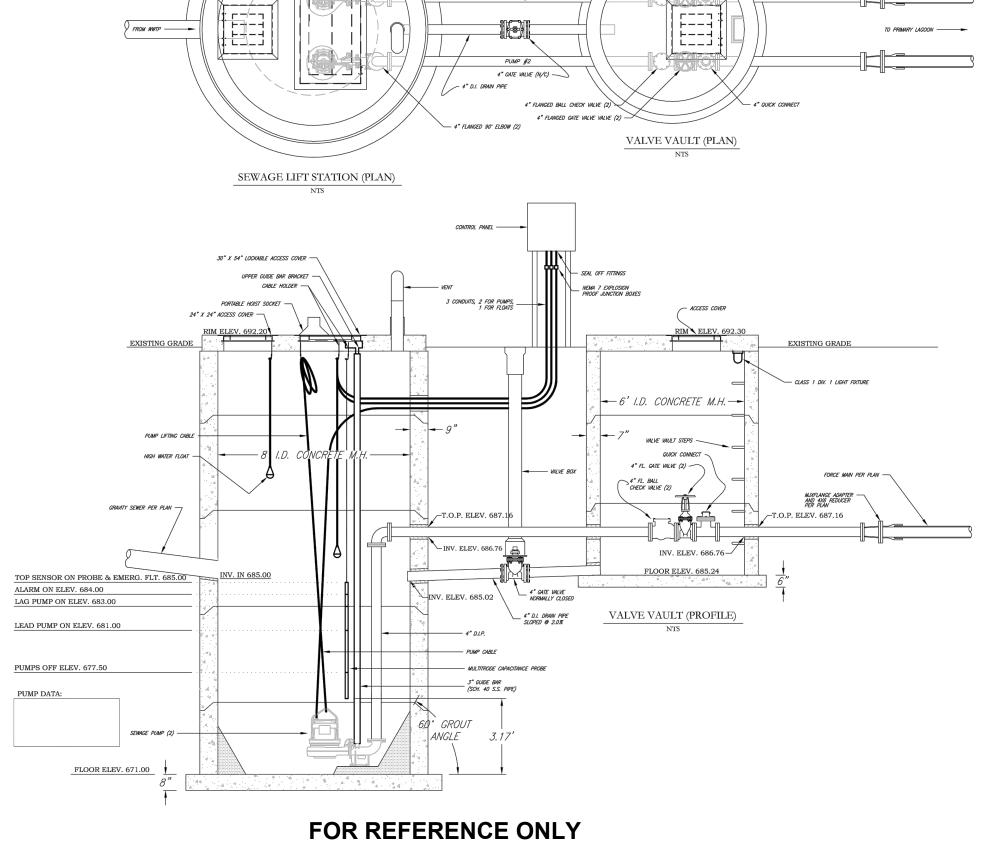

EXISTING LAGOON LIFT STATION PLANS

SCALE: NOT TO SCALE

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engineering sciences, inc

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ENVIRONMENTAL SERVICES
GEOTECHNICAL
CONSTRUCTION SERVICES
DRILLING
LANDSCAPE ARCHITECTURE

lo. Date Revision By

SEPTAGE UNLOADING DETAIL
HEADWORKS ADDITION
LITTLE RIVER BAND OF OTTAWA INDIANS

Date Surveyed: 08/10/2021
Designed By: ALT
Drawn By: ALT
Checked By: GLW
Scale: AS NOTED

Original sheet size is 22x34

Location:
PARTS OF SECTIONS 21 & 28,

10/29/2024


T 22 N, R 16 W,

MANISTEE TOWNSHIP,

MANISTEE COUNTY,

MICHIGAN

Project Number: 2021096001.00

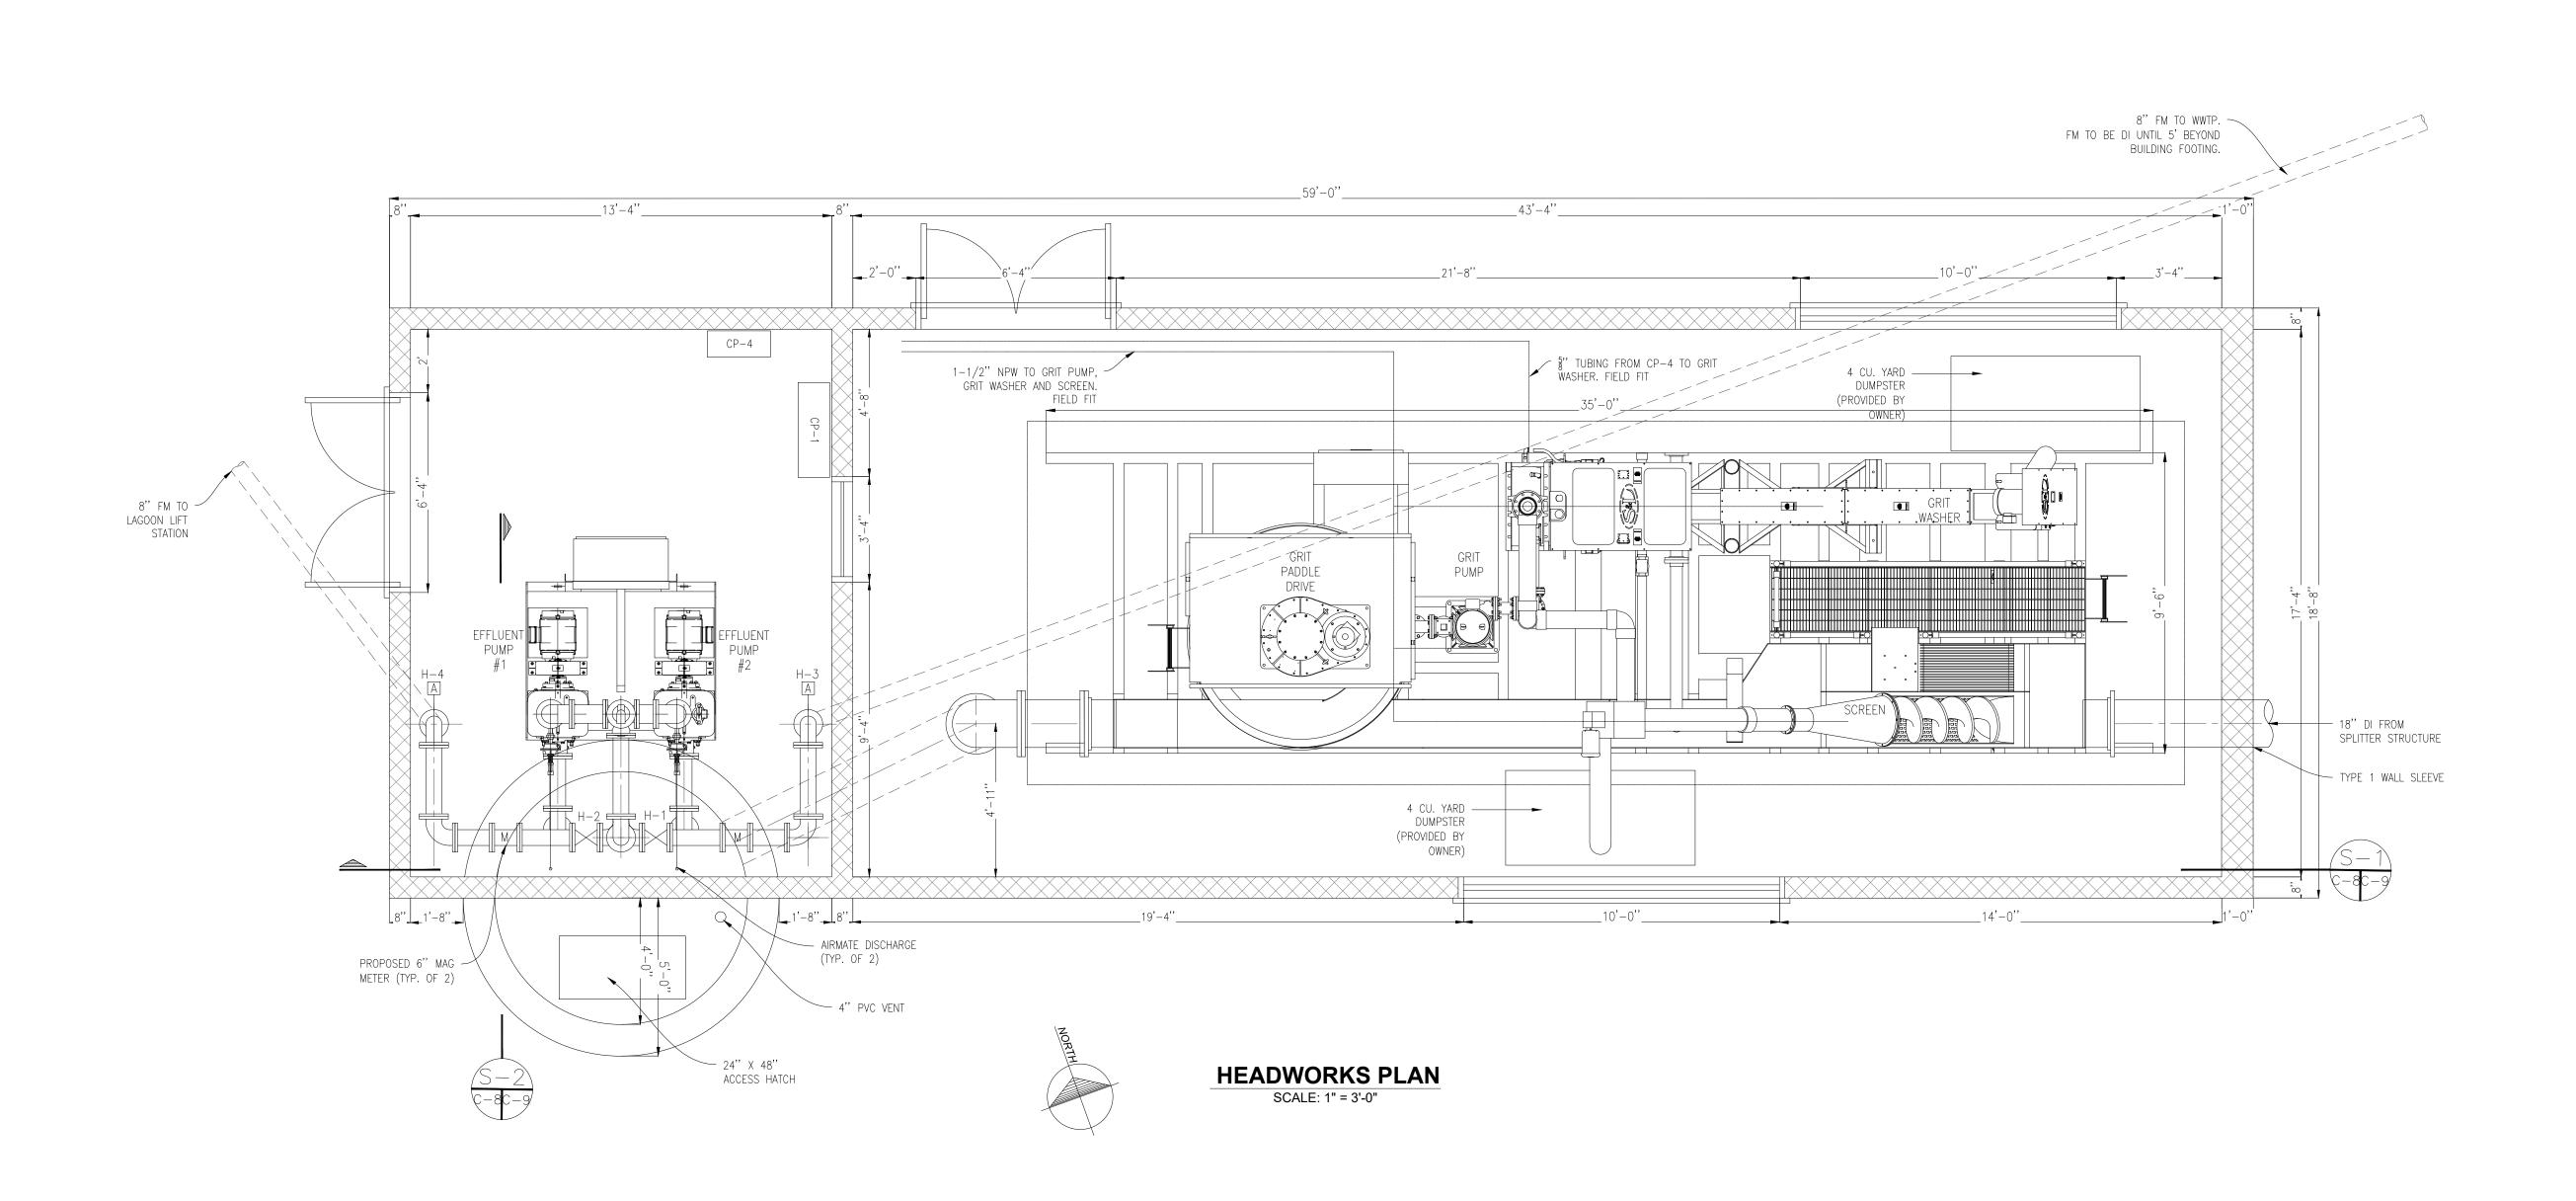

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CIVIL ENGINEERING SURVEYING ENVIRONMENTAL SERVICES
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CONSTRUCTION SERVICES
DRILLING
LANDSCAPE ARCHITECTURE

HEADWORKS EQUIPMENT PLAN HEADWORKS ADDITION LITTLE RIVER BAND OF OTTAWA INDIANS

Date Surveyed: Designed By: Drawn By: Checked By:

Date Issued:

Original sheet size is 22x34

PARTS OF SECTIONS 21 & 28,

T 22 N, R 16 W, MANISTEE TOWNSHIP, MANISTEE COUNTY, MICHIGAN

8/10/2021

AS NOTED

Project Number: 2021096001.00

**C-8** 

IS SHOWN. ANY DISCREPANCIES BETWEEN THE PLANS AND SHOP DRAWINGS SHALL BE BROUGHT TO THE ATTENTION OF THE ENGINEER AND OWNER. 3. ALL EQUIPMENT LOCATED IN THE SCREENING ROOM MUST MEET

ELECTRICAL CONNECTIONS AS REQUIRED BY MANUFACTURER AND

1. SCREEN/GRIT IS A PREPACKAGED UNIT ARRIVING ON A SKID.

AS SHOWN ON THE PLANS AND SPECIFICATIONS.

CLASS 1 DIVISION 1 REQUIREMENTS.


SHOWN ON THE PLANS AND SPECIFICATIONS.


CONTRACTOR SHALL MAKE ALL REQUIRED MECHANICAL AND

2. FINAL EQUIPMENT LAYOUT AND DIMENSIONS MAY VARY FROM WHAT

4. PUMPING EQUIPMENT SHALL COME PREPACKAGED ON A SKID.

CONTRACTOR SHALL MAKE ALL REQUIRED MECHANICAL AND ELECTRICAL CONNECTIONS REQUIRED BY MANUFACTURER AND AS

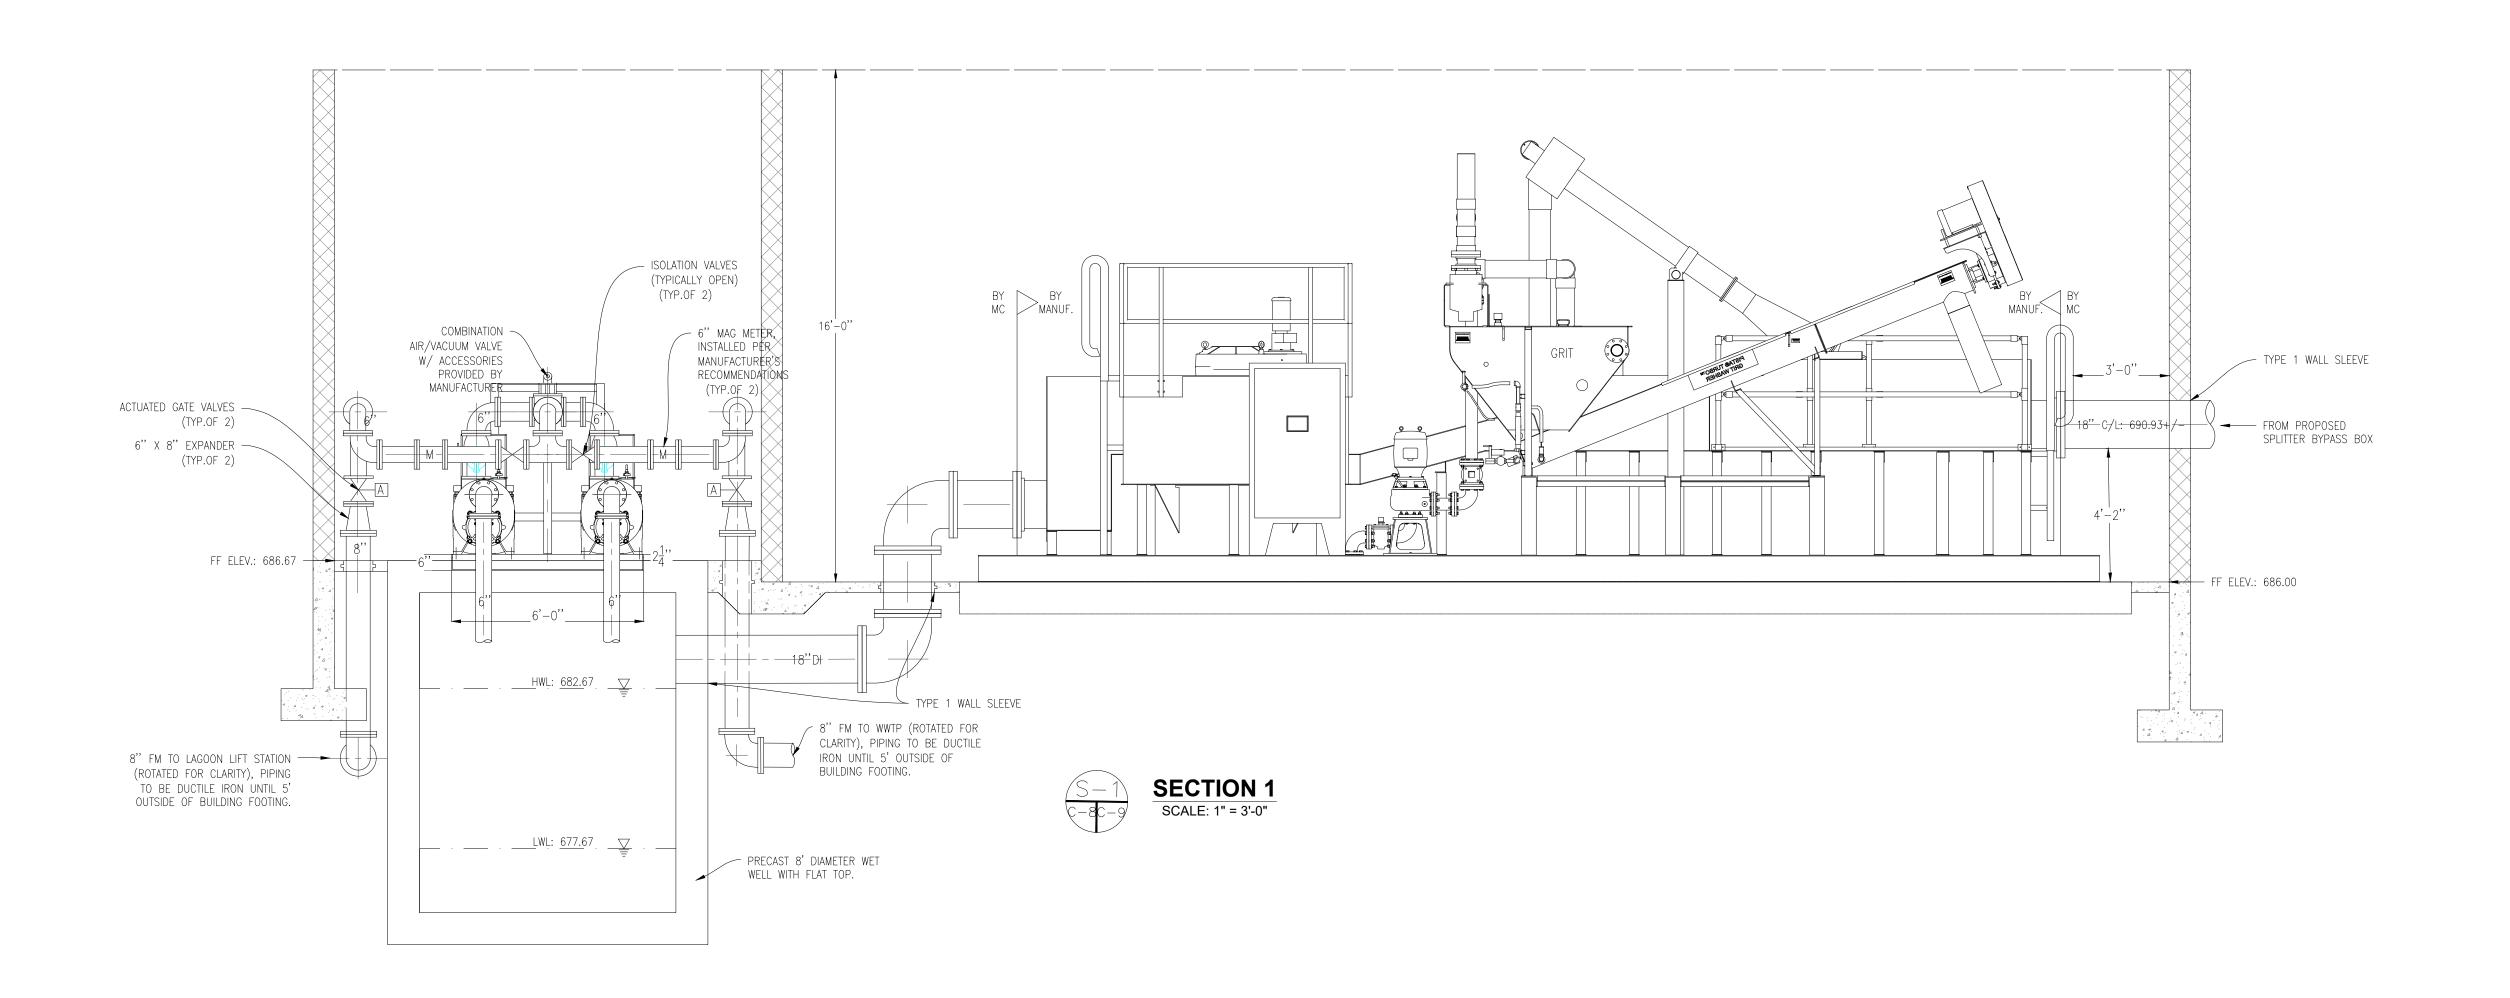

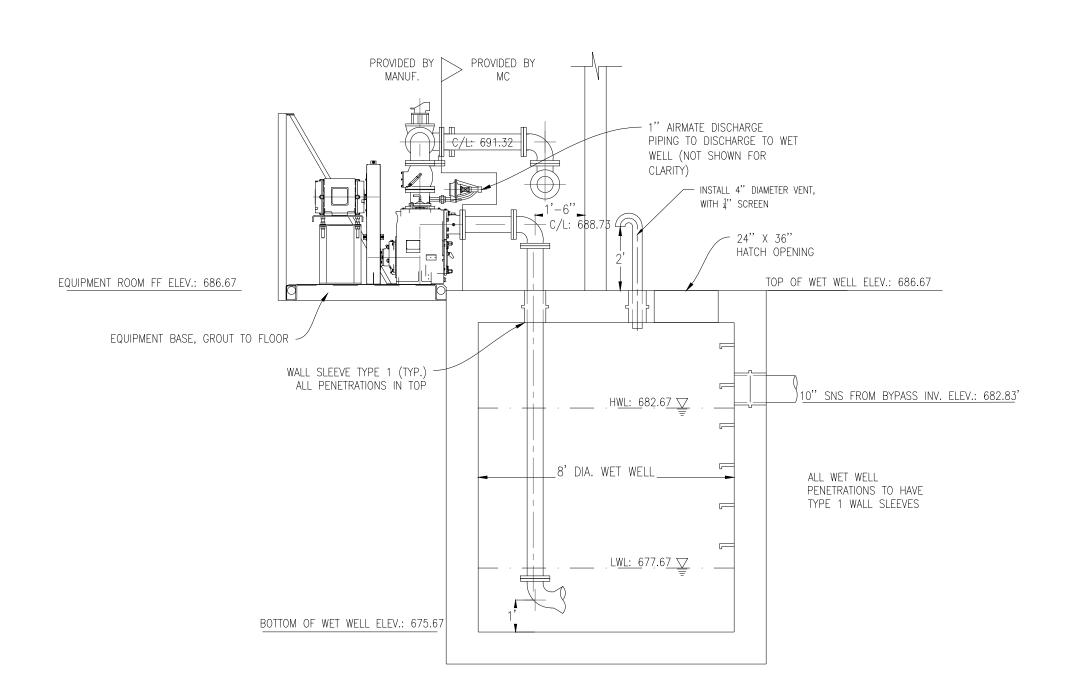




NOTES: 1. SEE ARCHITECTURAL PLANS FOR BUILDING AND FOOTING

- DETAILS. 2. ALL EQUIPMENT IS TO BE INSTALLED PER MANUFACTURER'S RECOMMENDATIONS.
- FINAL DIMENSIONS AND ELEVATIONS TO BE DETERMINED BASED ON SHOP DRAWING SUBMITTALS.
   ALL PROCESS PIPING TO BE DUCTILE IRON UNLESS OTHERWISE NOTED ON PLANS.

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Traverse City, Michigar 231-946-9191 phone info@goslingczubak.com www.goslingczubak.com

CIVIL ENGINEERING SURVEYING **ENVIRONMENTAL SERVICES** GEOTECHNICAL CONSTRUCTION SERVICES DRILLING LANDSCAPE ARCHITECTURE

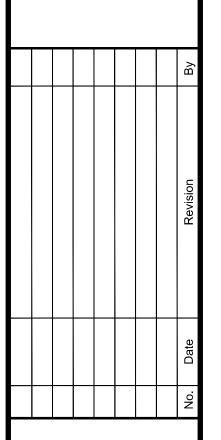


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3/10/2022 8/10/2021 Date Surveyed: Designed By: Drawn By: Checked By: AS NOTED

Original sheet size is 22x34 PARTS OF SECTIONS 21 & 28,

T 22 N, R 16 W, MANISTEE TOWNSHIP, MANISTEE COUNTY, MICHIGAN

Project Number: 2021096001.00

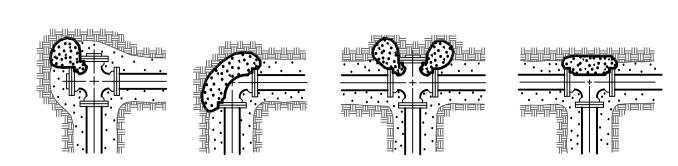

THE MINIMUM BEARING AREA, AGAINST UNDISTURBED EARTH, OF THE VARIOUS THRUST BLOCKS, SHALL BE AS FOLLOWS:

6" MAIN 2.0 S.F.


8" MAIN 3.0 S.F.

10" MAIN 5.0 S.F.


12" MAIN 7.0 S.F.

16" MAIN 12.0 S.F.


(BASED ON AN ALLOWED BEARING PRESSURE OF 2500 P.S.F.)
ALL THRUST BLOCKS ARE TO BE 3000 P.S.I. HIGH EARLY

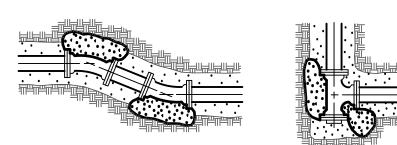



TYPICAL THRUST BLOCK DETAILS

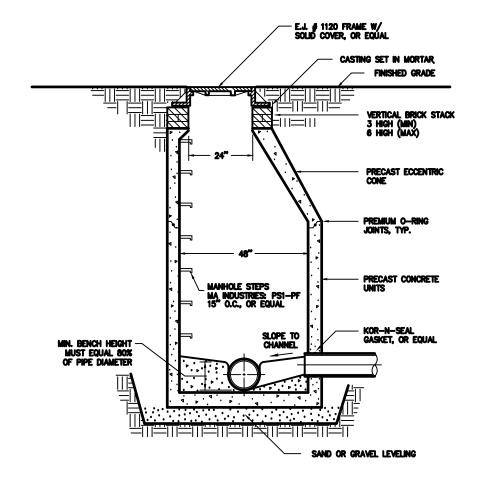


SANITARY MANHOLE DETAIL NO SCALE

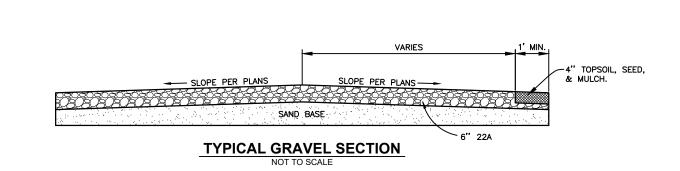


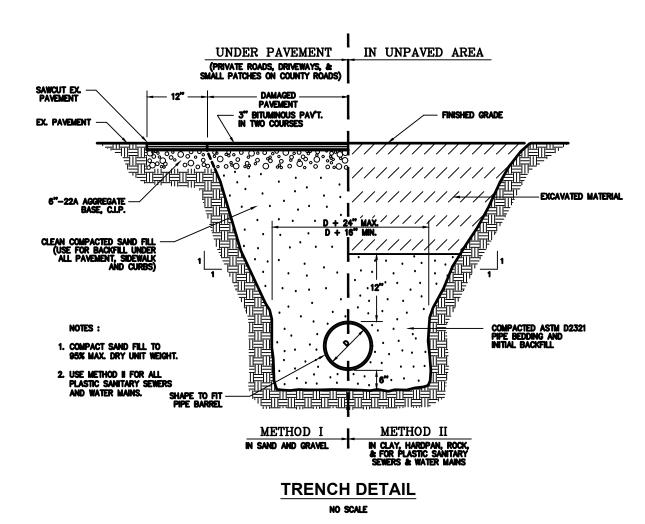


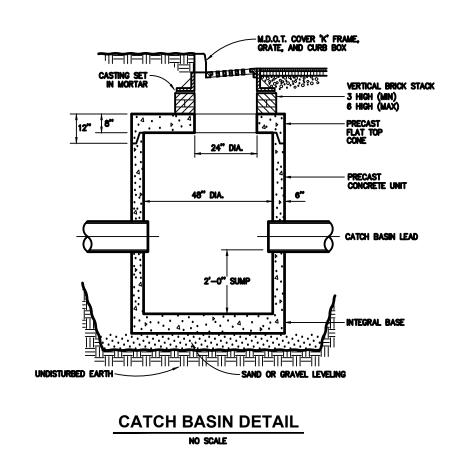

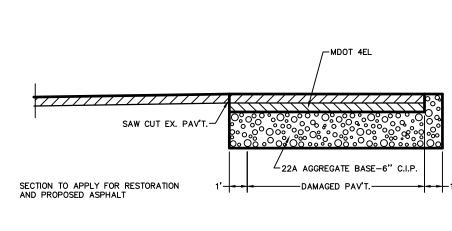





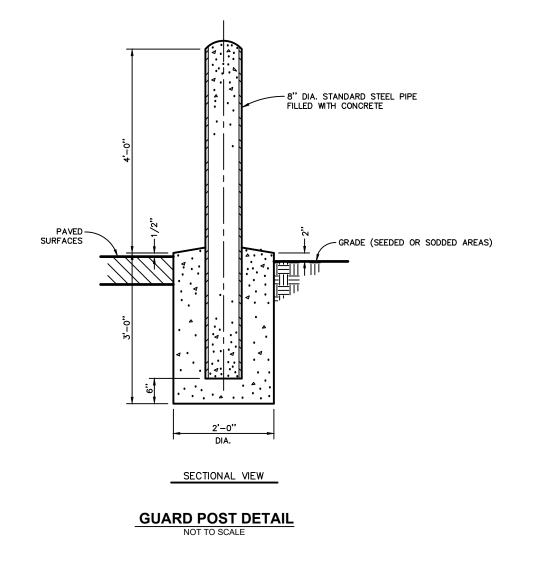

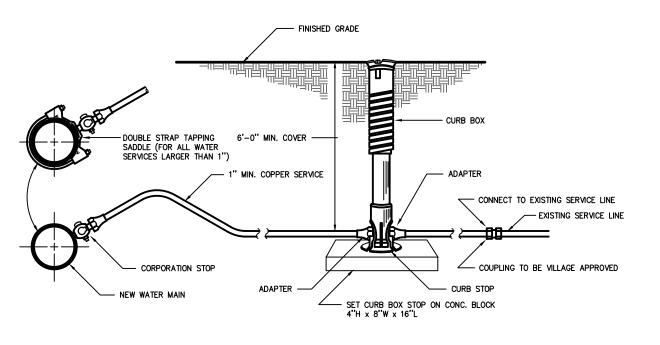

WATER MAIN SERVICE CONNECTIONS
NO SCALE

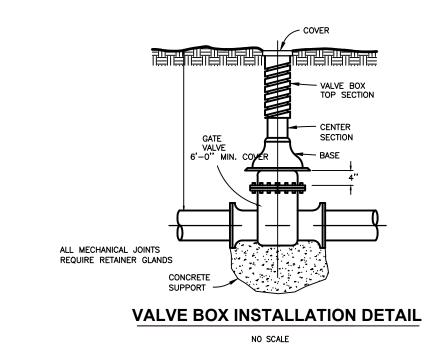

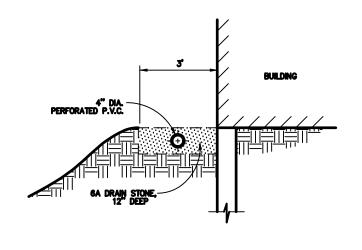


GRAVEL DRAIN DETAIL

Gosling Gzubak
engineering sciences, inc.

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231-946-9191 phone
info@goslingczubak.com
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LANDSCAPE ARCHITECTURE

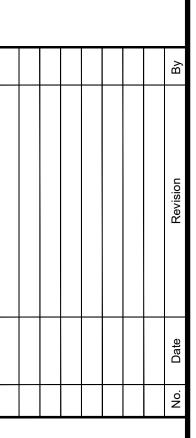

SITE DETAILS
HEADWORKS ADDITION
LITTLE RIVER BAND OF OTTAWA INDIANS


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Date Surveyed: 8/10/2021
Designed By: ---Drawn By: ALT
Checked By: GLW
Scale: AS NOTED


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Location:
PARTS OF SECTIONS 21 & 28,
T 22 N, R 16 W,
MANISTEE TOWNSHIP,

MANISTEE COUNTY,


MICHIGAN
Project Number:
2021096001.00




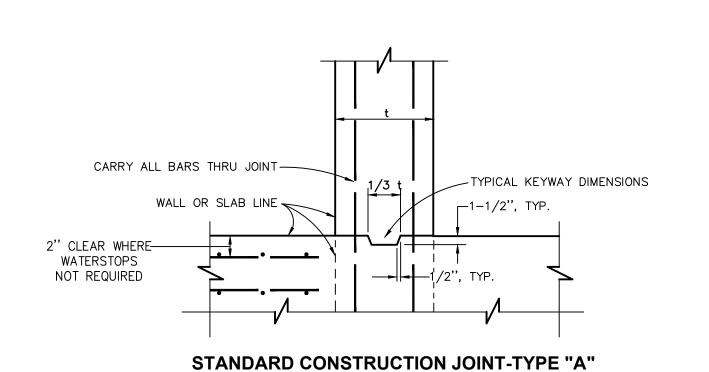

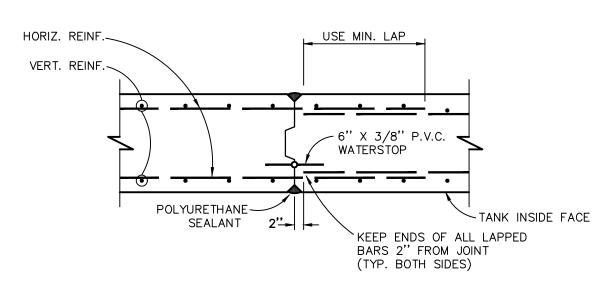TYPICAL WALL CONTROL JOINT-TYPE "D"


INDICATED BY SYMBOL ①

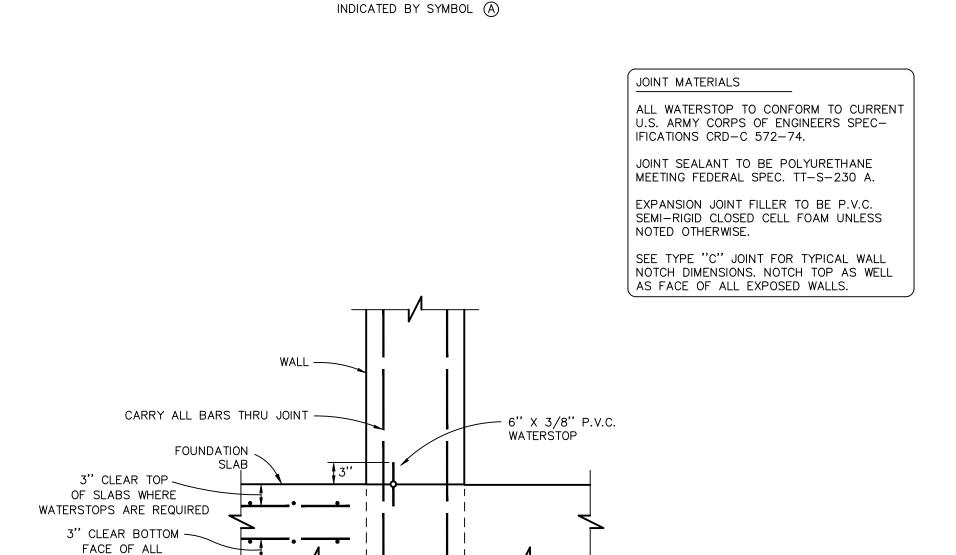

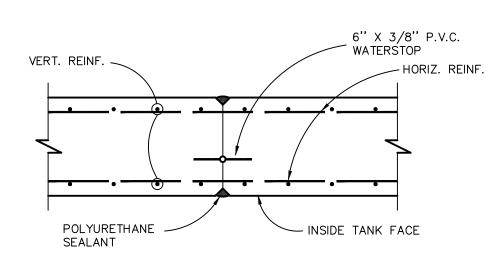


TYPICAL WALL CONTROL JOINT-TYPE "E"

INDICATED BY SYMBOL (E)

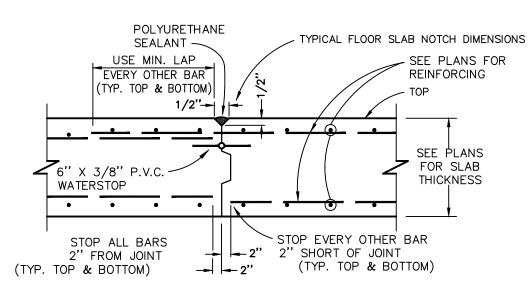

TYPICAL CONTROL JOINT IN TANK BOT.-TYPE "F"
INDICATED BY SYMBOL F

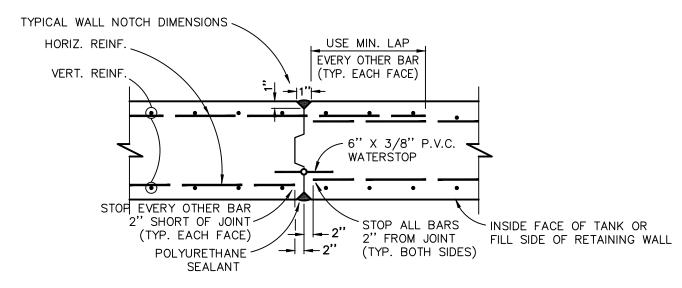

## TYPICAL WALL CONTROL JOINT-TYPE "C"


WATERTIGHT CONSTRUCTION JOINT-TYPE "B"

INDICATED BY SYMBOL B


INDICATED BY SYMBOL ©

FOUNDATION SLABS

NOTE:
SYMBOL (1) INDICATES JOINT IDENTICAL TO ABOVE,
EXCEPT THAT NO WATERSTOP IS REQUIRED.

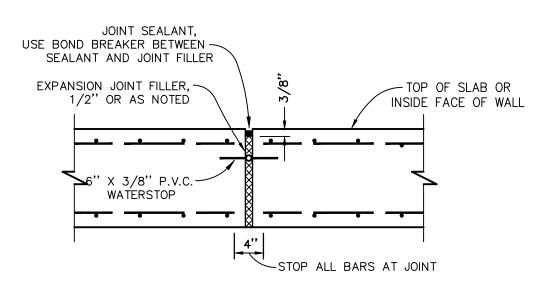


TYPICAL WALL & TANK BOTTOM
CONTROL JOINT-TYPE "G"
INDICATED BY SYMBOL ©

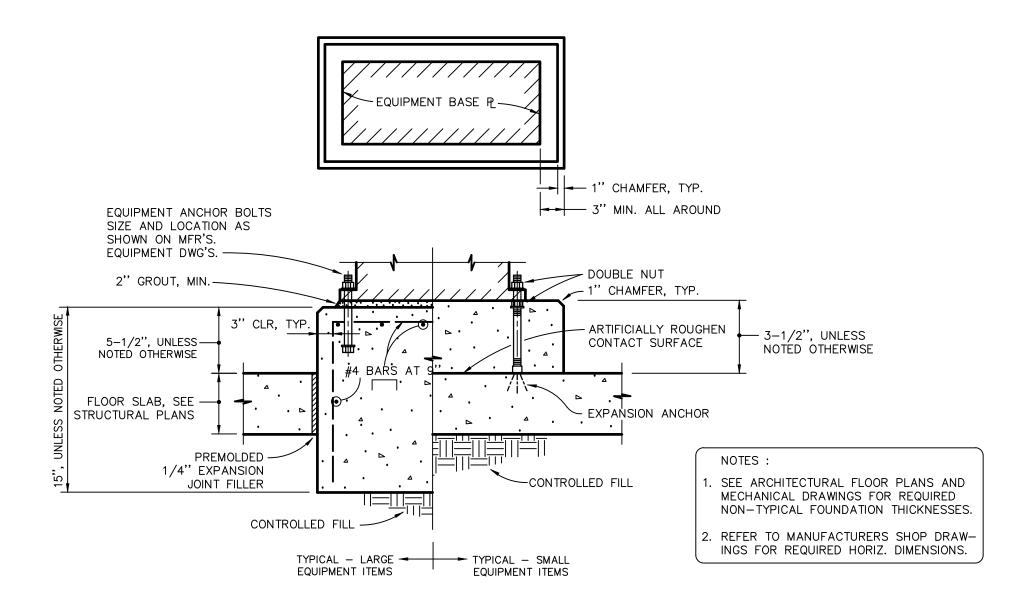

# **CONCRETE EQUIPMENT FOUNDATION**

NOT TO SCALE

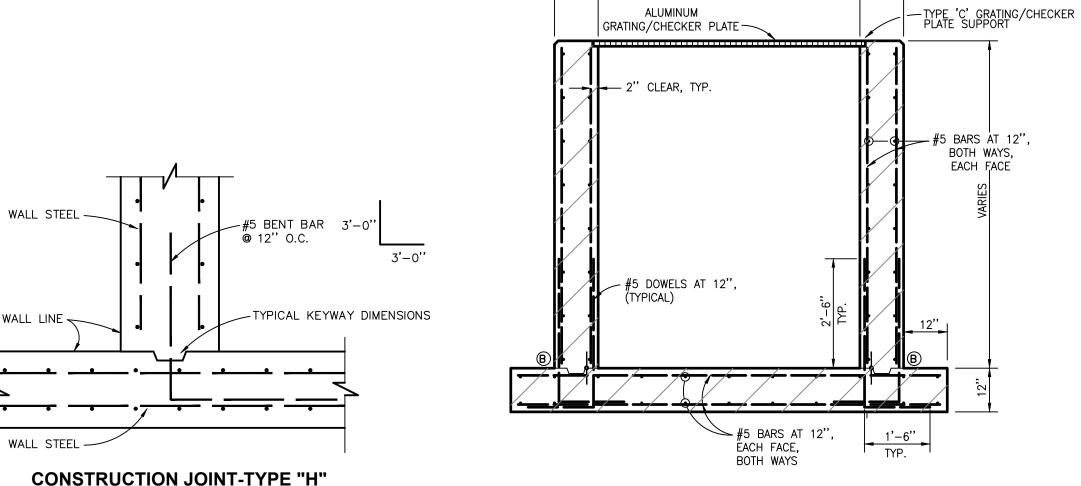

INDICATED BY SYMBOL (H)

# TYPICAL FLOW STRUCTURE SECTION


VARIES

NOT TO SCALE

NOTES :

1. THE LOCATION AND TYPE OF VERTICAL WALL CONSTRUCTION JOINTS TO BE APPROVED BY THE ENGINEER PRIOR TO CONSTRUCTION. IN GENERAL, ALL CONSTRUCTION JOINTS SHALL UTILIZE A WATERSTOP.

2. SEE STANDARD DETAILS FOR CORNER STEEL REQUIREMENTS.

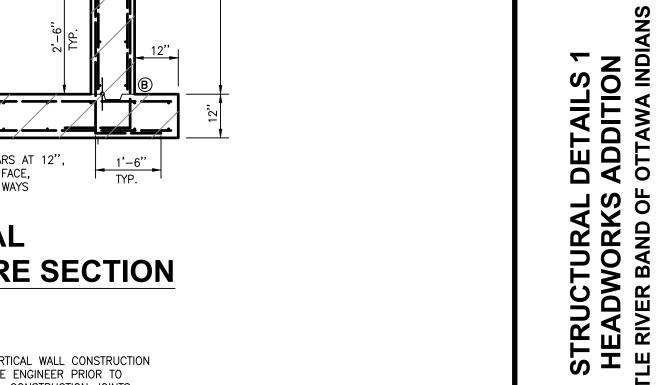

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Designed By: ---Drawn By: ALT
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Location:
PARTS OF SECTIONS 21 & 28,
T 22 N, R 16 W,
MANISTEE TOWNSHIP,
MANISTEE COUNTY,

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ENVIRONMENTAL SERVICES


GEOTECHNICAL CONSTRUCTION SERVICES

DRILLING

LANDSCAPE ARCHITECTURE

Project Number: 2021096001.00

MICHIGAN

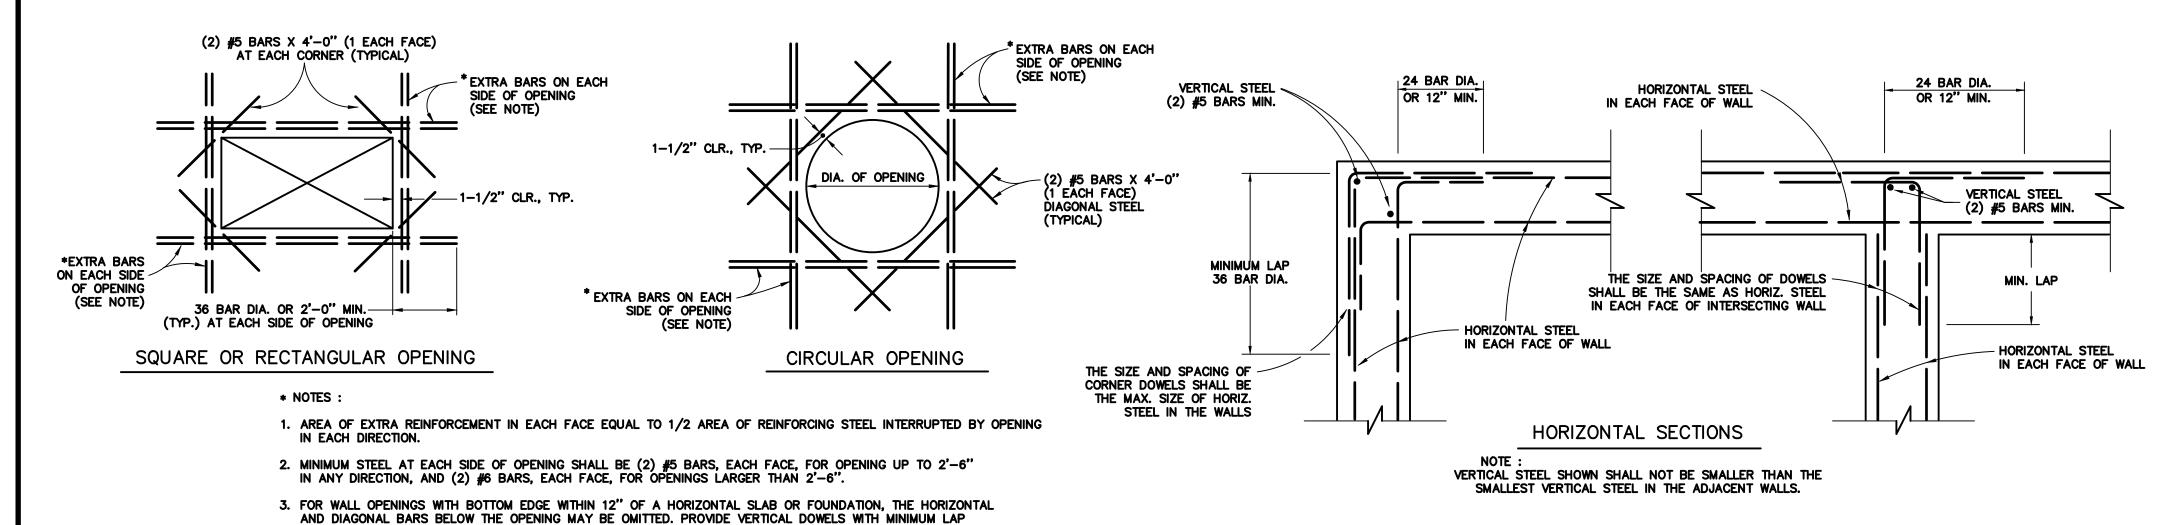


# **CORNER REINFORCING DETAILS**


NOT TO SCALE

# OPENINGS IN WALL & FLOOR SLABS NOT TO SCALE

TYPICAL REINFORCING DETAILS AT

SPLICE FOR VERTICAL SIDE BARS.

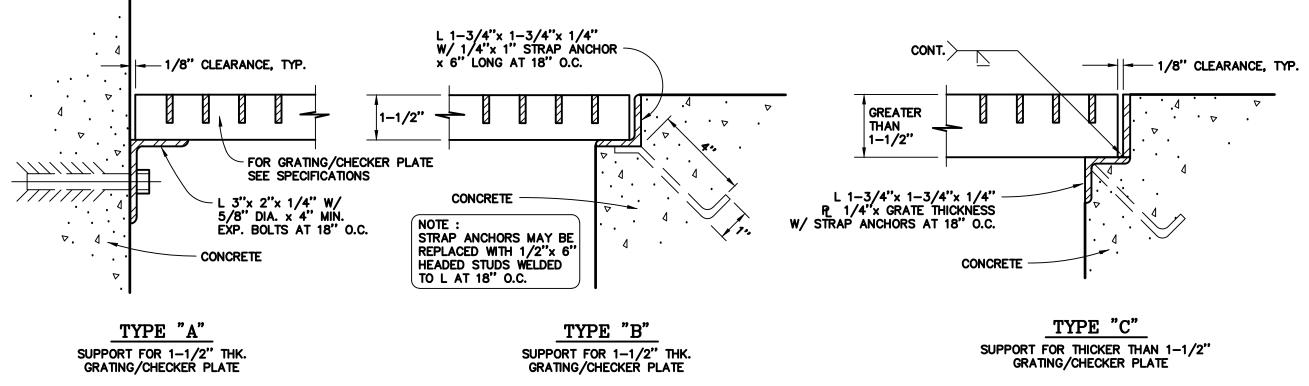

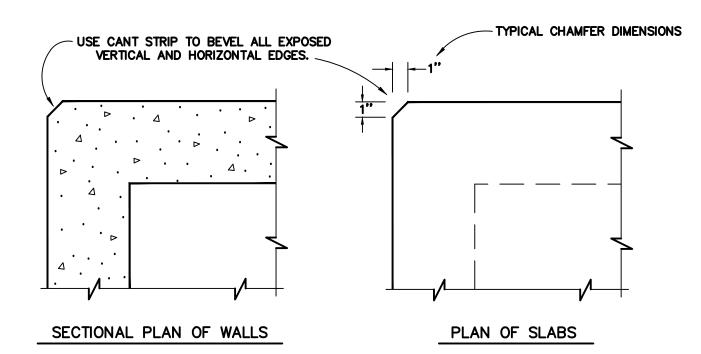


# **CHAMFER DETAILS**


NOT TO SCALE


# **GRATING/CHECKER PLATE SUPPORT DETAILS**


NOT TO SCALE

NOTES: 1. ALL STEEL ITEMS TO BE GALVANIZED UNLESS OTHERWISE SPECIFIED.

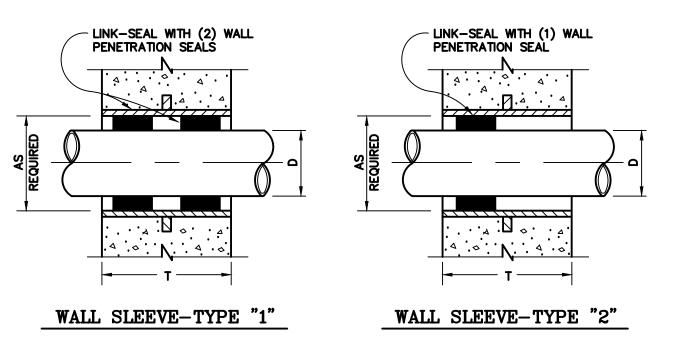

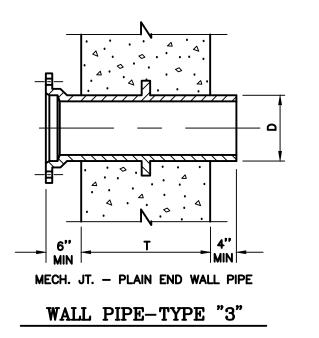

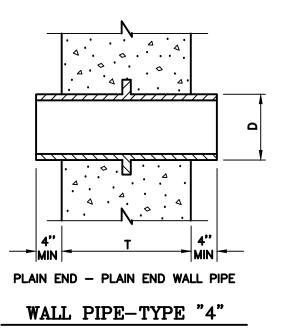

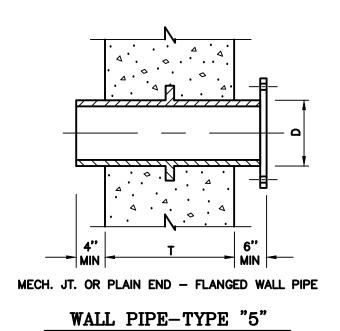

# WALL SLEEVE DETAILS

NOT TO SCALE

#### GENERAL NOTES

- 1. FOUNDATIONS SHALL REST ON SOIL HAVING A MINIMUM ALLOWABLE BEARING CAPACITY OF 2000 PSF. NOTED FOUNDATIONS SHALL REST ON ENGINEERED GRANULAR FILL BUILT UP FROM NATURAL UNDISTURBED STRATAS. FOUNDATIONS SHALL NOT BE PLACED ON EXISTING FILL, ORGANIC MATERIALS, OR ON FROZEN GROUND. TANK BOTTOMS OR STRUCTURE FOUNDATIONS WHICH OTHERWISE WOULD REST PARTLY ON ENGINEERED FILL SHALL BE UNDERCUT A MINIMUM OF 24" SO THAT THEY REST ENTIRELY ON ENGINEERED FILL. SEE SPECIFICATIONS AND COMPONENT DRAWING NOTES.
- 2. ALL DESIGN, DETAILING, FABRICATION, ERECTION, CONCRETE COVER, INSERTS, SUPPORTS, AND ACCESSORIES FOR CONCRETE WORK SHALL CONFORM TO THE FOLLOWING STANDARDS UNLESS OTHERWISE SHOWN: ACI 318, ACI 301, ACI 315, ACI 350, LATEST EDITIONS.
- 3. ALL REINFORCING STEEL SHALL CONFORM TO ASTM-A615 GRADE 60. CONCRETE SHALL HAVE A MINIMUM 28 DAY STRENGTH OF 4,000 PSI. THE  $C_3A$  CONTENT OF ALL CEMENTITIOUS MATERIAL SHALL BE LESS THAN 8 PERCENT FOR ALL CONCRETE IN DIRECT CONTACT WITH SEWAGE OR FEFLUENT.
- 4. MINIMUM REINFORCEMENT FOR WALLS 8" AND THICKER SHALL BE #5 @ 12" C/C EACH WAY EACH FACE, AND FOR 6" WALLS #4 @ 12" C/C EACH WAY AT THE CENTER, UNLESS OTHER—WISE SHOWN ON THE DRAWINGS OR APPROVED BY THE ENGINEER.
- 5. LOCATIONS AND SIZES OF ALL OPENINGS, SLEEVES, FLOOR DRAINS, PIPING, DIMENSIONS OF CONCRETE EQUIPMENT BASE FOUNDATIONS, CURBS, ETC. SHALL BE GENERALLY AS SHOWN ON THE PLANS BUT MAY BE CHANGED TO SUIT EQUIPMENT FURNISHED IF APPROVED BY THE ENGINEER. VERIFY SIZE AND LOCATION WITH THE MECHANICAL, ELECTRICAL, AND EQUIPMENT DRAWINGS.
- 6. ALL SLEEVES, INSERTS, ANCHOR BOLTS, AND OTHER EMBEDDED ITEMS SHALL BE PLACED IN THE FORMWORK PRIOR TO PLACING THE CONCRETE.
- 7. ALL SLABS ON GRADE, EXCEPTING FOUNDATION SLABS, SHALL REST ON A MINIMUM OF 6" OF ENGINEERED GRANULAR FILL BUILT UP FROM UNDISTURBED STRATA.
- 8. (DELETED)
- 9. BACKFILL SHALL BE PLACED UNIFORMLY ON BOTH SIDES OF THE FOUNDATION WALLS. DO NOT BACKFILL BASEMENT WALLS UNTIL THE FLOOR SLABS ABOVE HAVE BEEN PLACED, UNLESS ADEQUATE BRACING AND SHORING FOR THE WALL IS PROVIDED.
- 10. SEE MECHANICAL DRAWINGS FOR SIZE, LOCATION, AND MATERIAL FOR GRATINGS, CHECKERED PLATES, HATCH COVERS, AND HANDRAILS.
- 11. COORDINATE STRUCTURAL DRAWINGS WITH EQUIPMENT MANUFACTURERS. CHANGES REQUIRED BY THE EQUIPMENT MANUFACTURER SHALL BE SUBJECT TO APPROVAL BY THE ENGINEER. ANY ADDITIONAL COST CAUSED BY SELECTED EQUIPMENT SHALL BE BORN BY THE
- 12. TYPICAL LAP LENGTHS FOR REBAR SPLICES ARE GIVEN BELOW. IF SPLICES ARE REQUIRED BETWEEN CONTROL JOINTS, LOCATION OF SPLICES SHALL BE STAGGERED. ALL SPLICES IN CIRCULAR TANK WALLS SHALL BE STAGGERED.

TYPICAL MII	TYPICAL MINIMUM LAP LENGTH IN INCHES*									
BAR SIZE	TYPICAL TOP ** BARS BARS									
#4	25	32								
#5	31	40								
#6	37	48								
#7	54	70								
#8	62	80								

- \* LAP SPLICE LENGTHS SHOWN TO ALL MEMBERS UNLESS OTHERWISE NOTED ON THE DRAWINGS: ACI CLASS B SPLICE.
- \*\* TOP BARS ARE HORIZONTAL BARS IN SLABS, JOISTS, AND BEAMS WITH 12 INCH OR MORE OF CONCRETE CAST BELOW THE BARS.

## **ABBREVIATIONS**

E.F. = EACH FACE

E.W. = EACH WAY

T.O.W. = TOP OF WALL

T.O.S. = TOP OF SLAB

T = TOP

B = BOTTOM N & S = NORTH & SOUTH

E & W = EAST & WEST

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CONSTRUCTION SERVICES
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LANDSCAPE ARCHITECTURE

No. Date Revision By

STRUCTURAL DETAILS 2
HEADWORKS ADDITION
LITTLE RIVER BAND OF OTTAWA INDIANS


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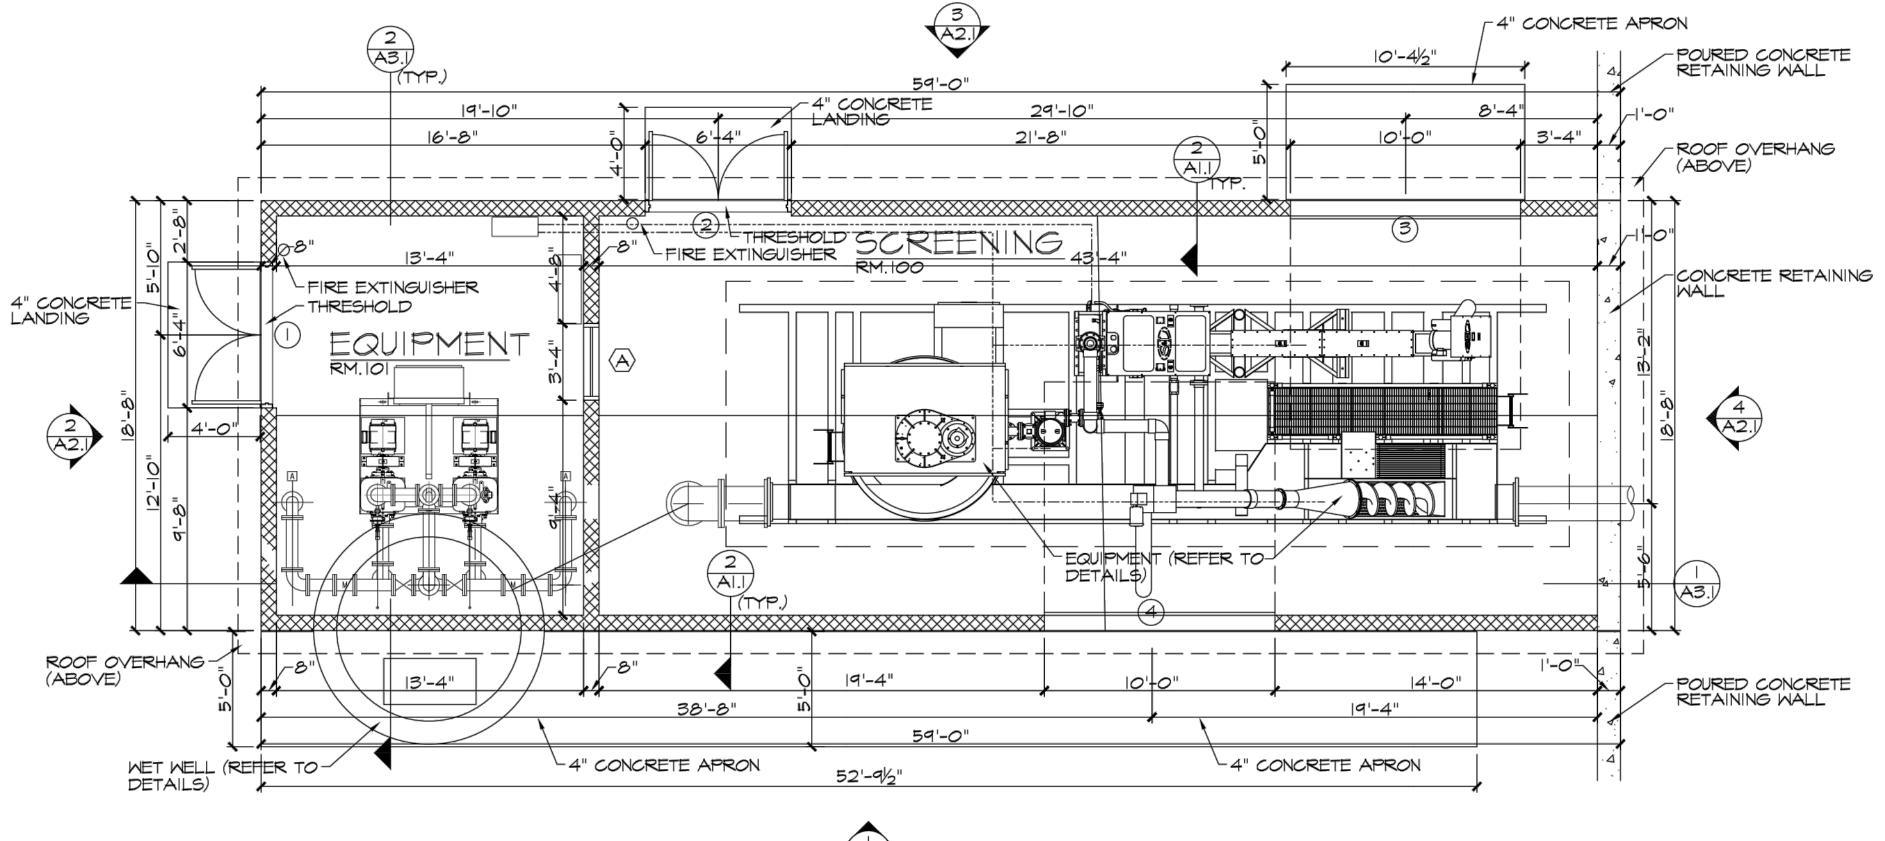
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MANISTEE TOWNSHIP,
MANISTEE COUNTY,
MICHIGAN

Project Number: 2021096001.00







# 2 TYP. WALL SECTION AI.I SCALE: 1/2" = 1'-0"

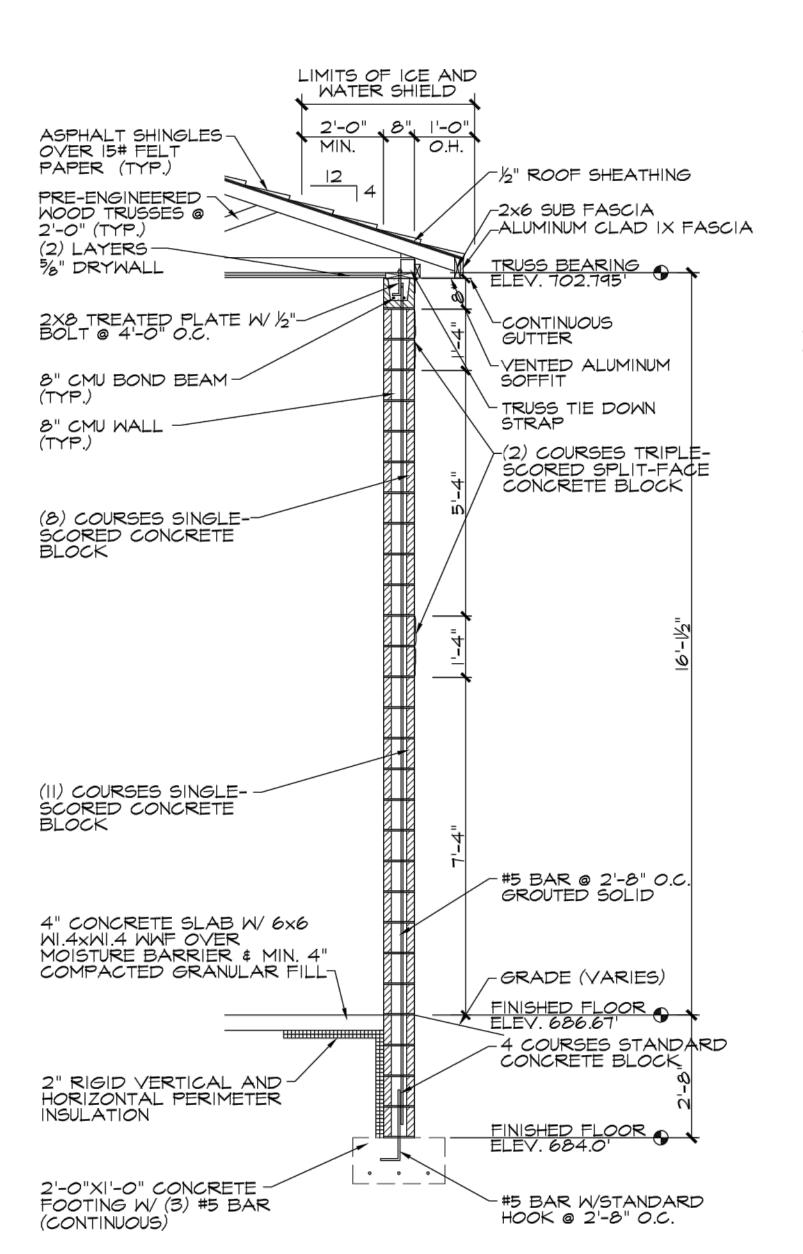MIN	DOW SCHE	DULE		
TAG	LOCATION	SIZE	FRAME	NOTES
A	REFER TO PLANS	3'-4"x4'-0"	FIBERGLASS	FIXED WIRE GLASS

# WINDOW TYPES:

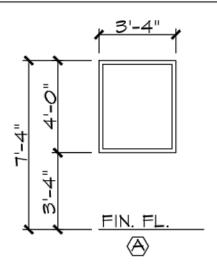

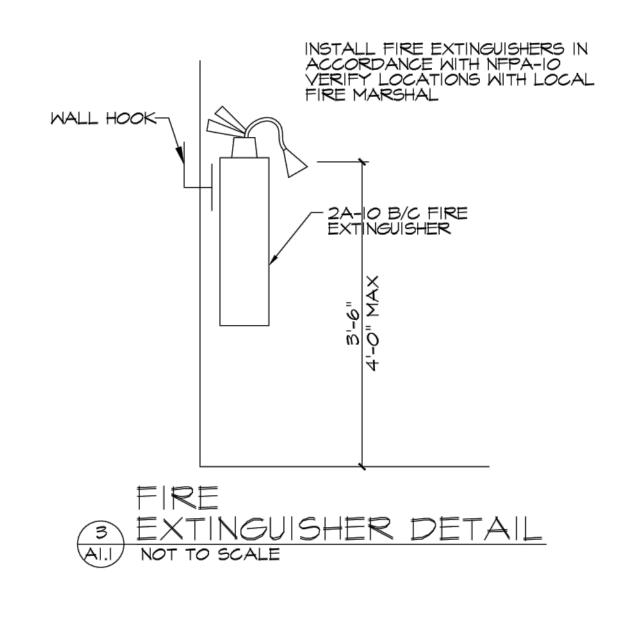

BUILDING PLANNI	NG	
BUILDING CODE REQUIREMENTS CONFORMS TO	2015 MICHIGAN I	BUILDING CODE
BUILDING USE GROUP	U UTIULITY	
CONSTRUCTION CLASSIFICATION	TYPE 5B	
FIRE SUPPRESSION SYSTEM	NO FIRE SUPPRE	SSION REQUIRED
BUILDING ALLOWED	TABULAR SF	FRONTAGE INCREASE SF
ALLOWED S.F.	5,500 SF	N/A
TOTAL ALLOWED S.F.	5,500 SF	
STORIES ALLOWED	(I) STORY	
HEIGHT ALLOWED	40'-0"	
BUILDING CONTAINS		
ACTUAL S.F.	1,101 SF	
ACTUAL STORIES	(I) STORY	
ACTUAL HEIGHT	19'-0"	
OCCUPANT LOAD	(4) PERSONS	
FIRE RESISTANCE RATINGS		
PRIMARY STRUCTURE FRAME	(O) HOURS	
EXTERIOR BEARING WALL	(O) HOURS	
INTERIOR BEARING WALL	(O) HOURS	
NON-BEARING WALLS/PARTITIONS	(O) HOURS	
FLOOR CONSTRUCTION	(O) HOURS	
ROOF CONSTRUCTION	(O) HOURS	
TENANT SEPARATION WALLS	(O) HOURS	
GENERAL NOTES		
	I	

Gosling Czubal engineering sciences, in 1280 Business Park Dr. Traverse City, Michigar 231-946-9191 phone info@goslingczubak.com www.goslingczubak.com CIVIL ENGINEERING SURVEYING ENVIRONMENTAL SERVICES GEOTECHNICAL CONSTRUCTION SERVICES DRILLING LANDSCAPE ARCHITECTURE FLOOR PLAN
HEADWORKS ADDITION
LE RIVER BAND OF OTTAWA INDIANS

Date Issued:
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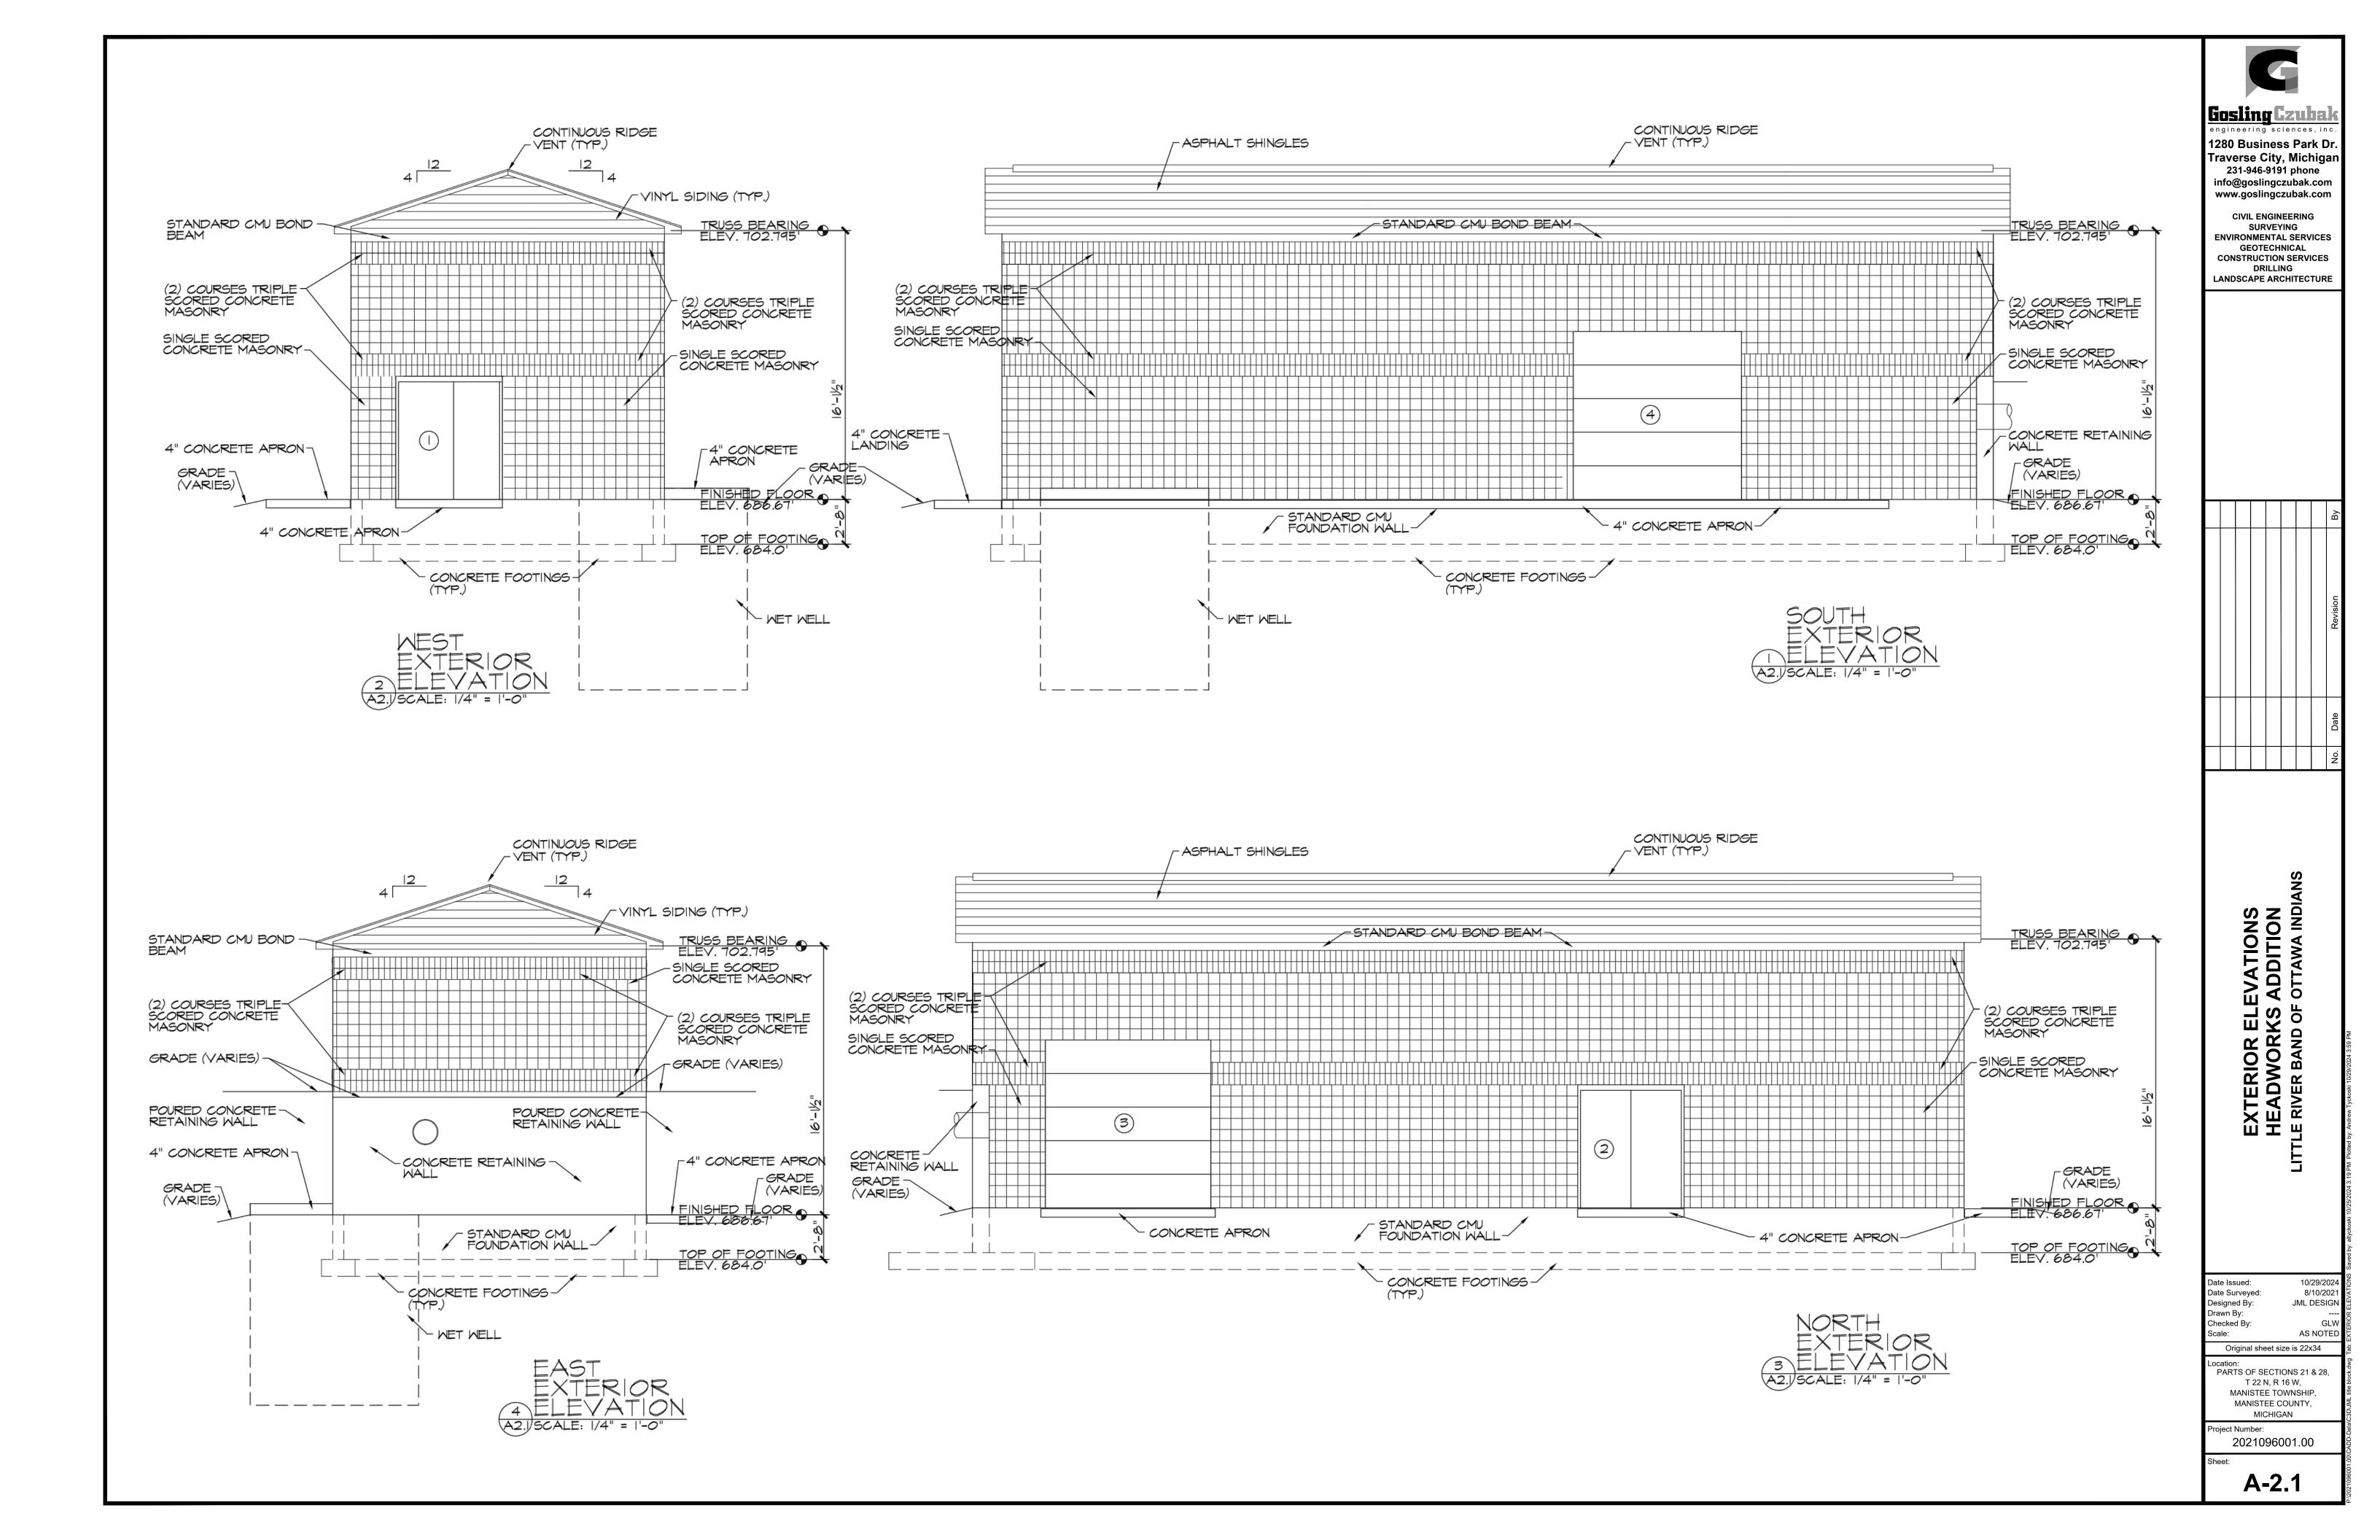
10/29/2024


8/10/2021 JML DESIGN

MANISTEE TOWNSHIP,
MANISTEE COUNTY,
MICHIGAN

Project Number: 2021096001.00

A-1.1



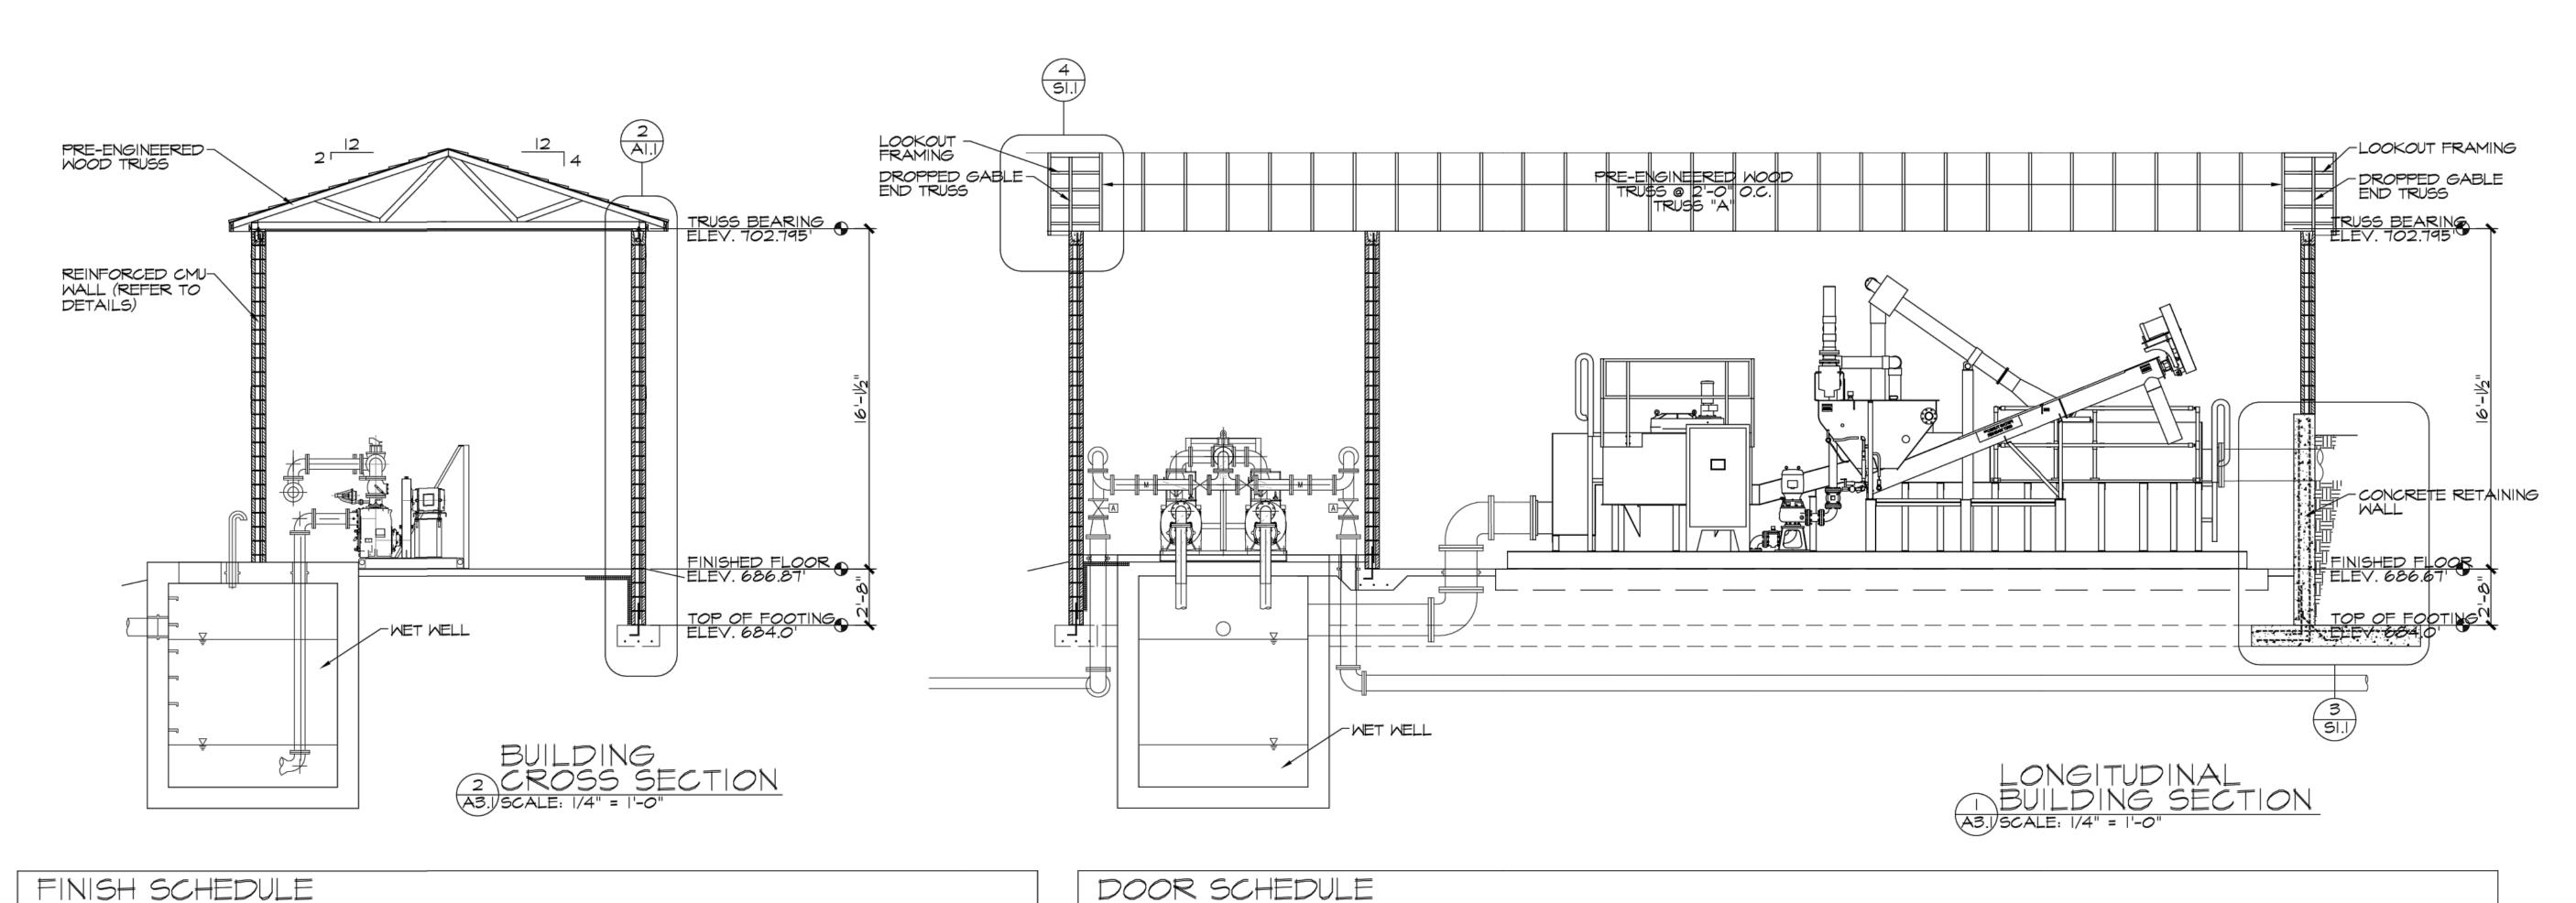

# MATERIAL SPECIFICATIONS:

16'-0"

16'-0"


CEILING | CLG. HT.

PTD-I

ASPHALT SHINGLES TO BE CERTIFIED LANDMARK 40 YR. ARCHITECTURAL GRADE "WEATHERED WOOD" OR APPROVED EQUAL.

CONCRETE MASONRY TO BE DECORATIVE BLOCK MANUFACTURED TO MATCH THE CONCRETE SERVICE INC. LT. EARTH BLEND OR APPROVED EQUAL.

PAINT TO BE (I) COAT PRIMER, (2) COATS FINISH, SEMI-GLOSS OR EPOXY - CEILING

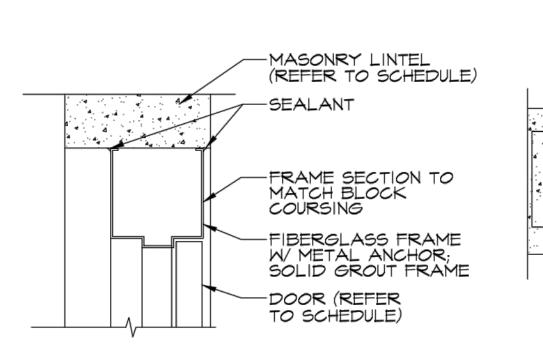

ROOM NAME

SCREENING ROOM

EQUIPMENT

HEAD DETAIL

4 EXTRIOR DOOR

A3.1/SCALE: 1/4" = 1'-0"



WALLS

EAST

CMU-I

CMU-1

WEST

CMU-I

CMU-I

SOUTH


CMU-1

CMU-1

NORTH

CMU-I

CMU-I

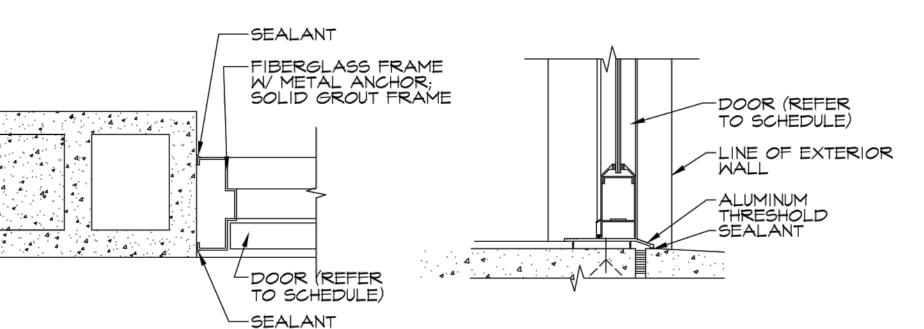

FLOORS

CONC.

CONC.

BASE

NO.

DOOR LOCATION

EQUIPMENT (RM. 101)

SCREENING (RM. 100)

SCREENING (RM. 100)



# DOOR TYPES:


SIZE

(2) 3'-0"X7'-0"X13/4

(2) 3'-0"XT'-0"X|3/2

10'-0" X 10'-0"

10'-0" X 10'-0"

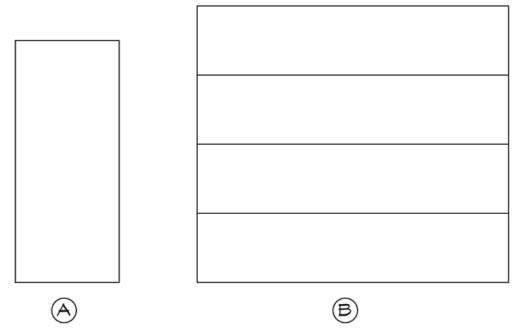

DOOR

MATERIAL

FIBERGLASS

INSUL.ALUM.

INSUL.ALUM.

# DOOR HARDWARE:

FRAME

4/A3.l

MATERIAL

FIBERGLASS

FIBERLGASS FIBERLGASS

HEAD JAMB SILL

4/A3.I 3/A3.I 2/A3.I

3/A3.I 2/A3.I

1/2 PAIR HINGES (PER DOOR) SILENCERS MORTISE LOCKSET (ACTIVE DOOR) CLOSER (ACTIVE DOOR) (I) SLIDE BOLTS (TOP&BOTTOM)(INACTIVE DOOR) THRESHOLD/WEATHER STRIPPING ASTRIGAL SWEEP

HDWR

## <u>SET 2:</u>


INT. SLIDE BOLT OVERHEAD DOOR TRACKS & TORSION BAR PROVIDED BY OVERHEAD DOOR MANUFACTURER

I. ALL LOCKS TO BE ON MASTER KEY SYSTEM WITH SUB KEYS. 2. WEATHERSTRIP ALL EXTERIOR DOORS.

NOTES

ADJ. FRAME HEAD TO MATCH CMU COURSING


ADJ. FRAME HEAD TO MATCH CMU COURSING

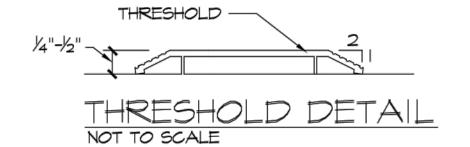

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CIVIL ENGINEERING SURVEYING **ENVIRONMENTAL SERVICES** GEOTECHNICAL **CONSTRUCTION SERVICES** LANDSCAPE ARCHITECTURE



SECTIONS
KS ADDITION
OF OTTAWA INDIANS BUILDING SIEADWORKS

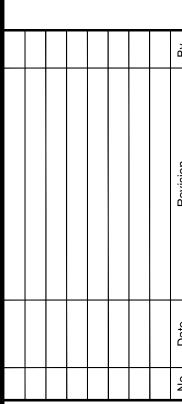
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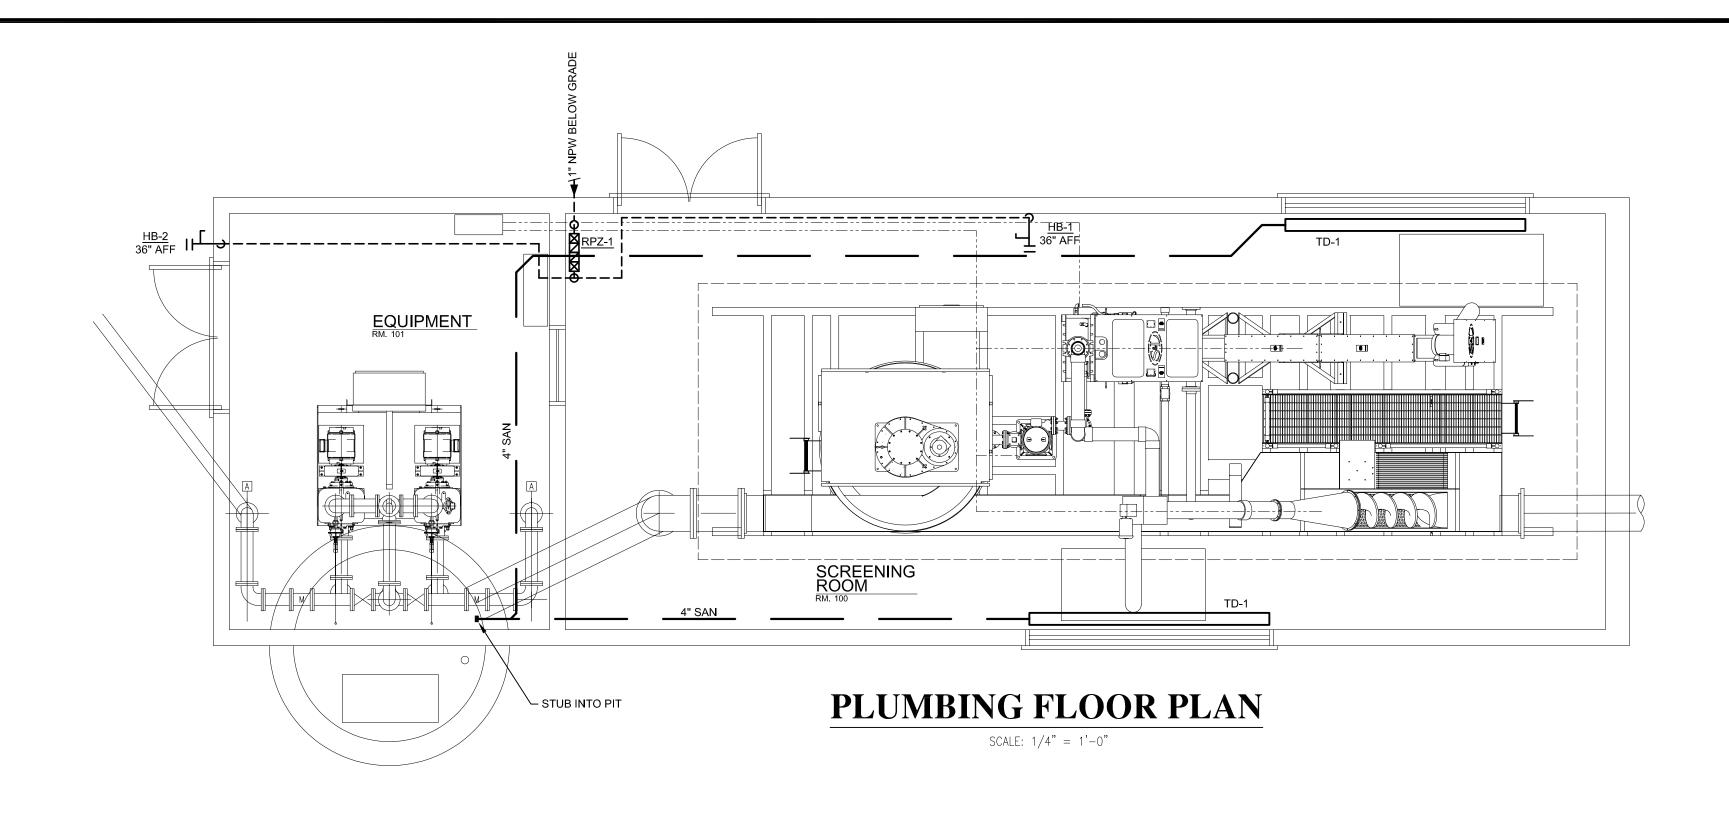
PARTS OF SECTIONS 21 & 28, T 22 N, R 16 W, MANISTEE TOWNSHIP,


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Project Number: 2021096001.00

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1	10-29-2024	ISSUED FOR BIDS	WDH
No.	Date	Revision	By

PROCESS MECHANICAL
HEADWORKS ADDITION
LITTLE RIVER BAND OF OTTAWA INDIANS

 Date Issued:
 10-29-2024

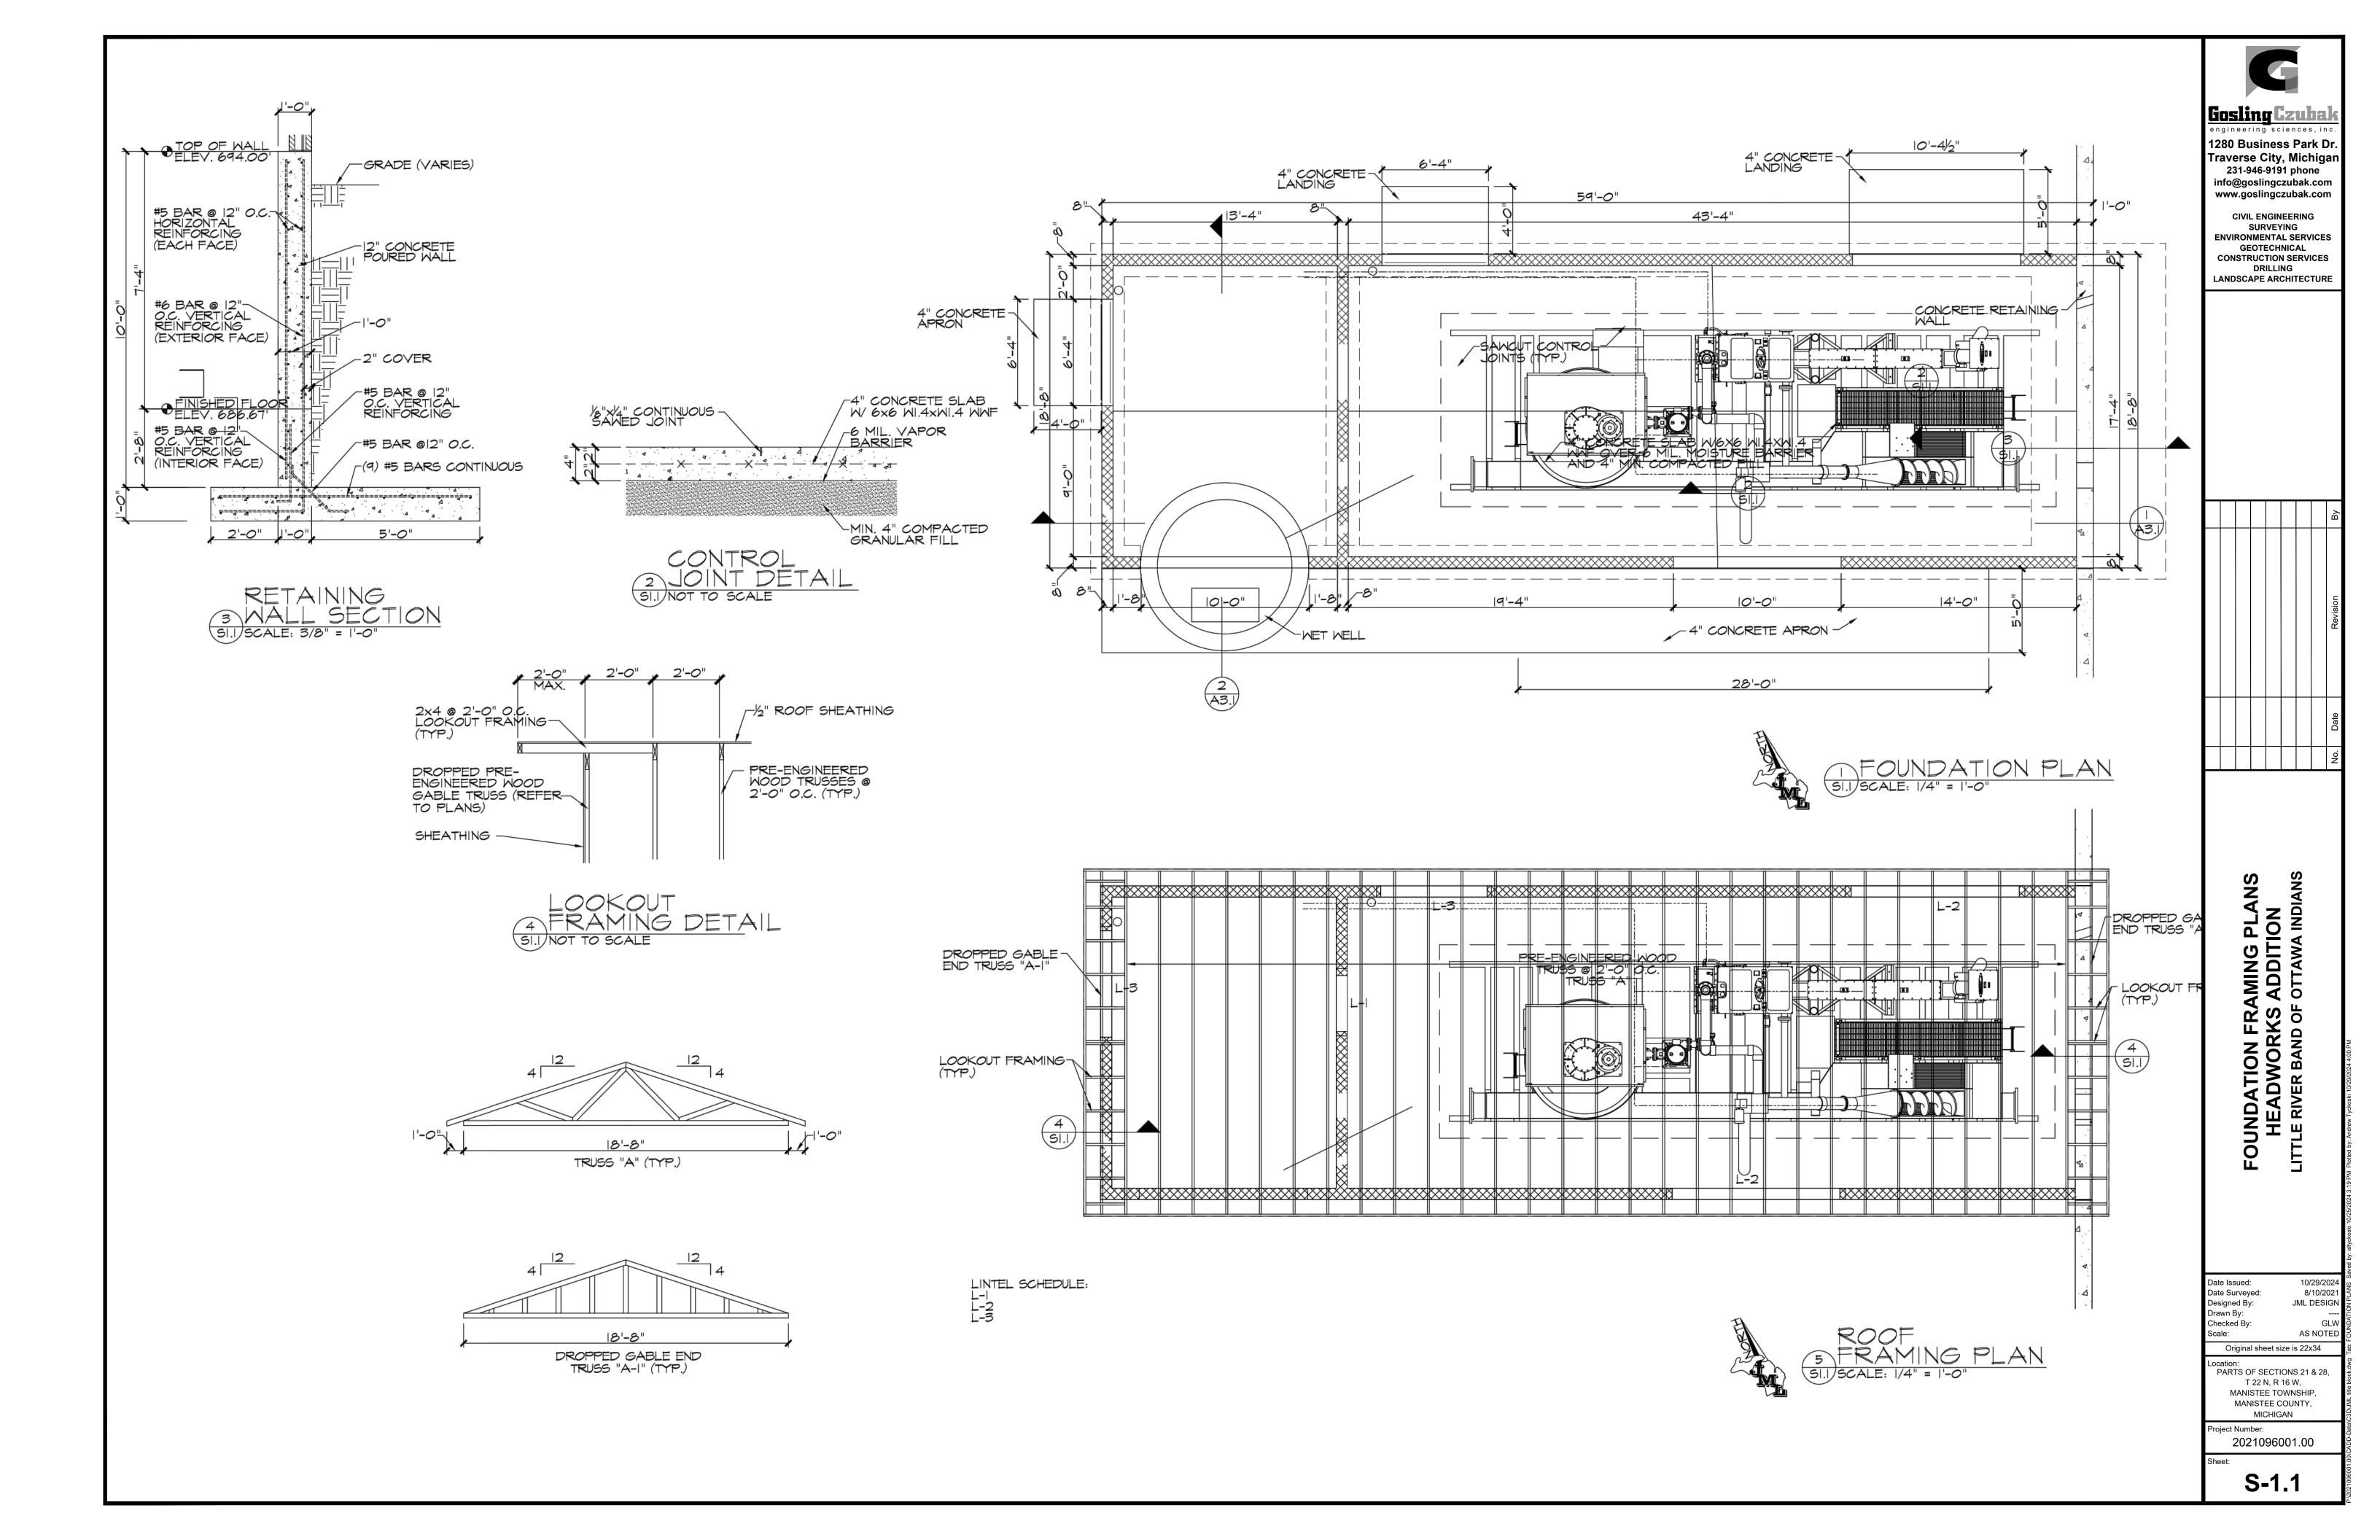 Date Surveyed:
 8-10-2021

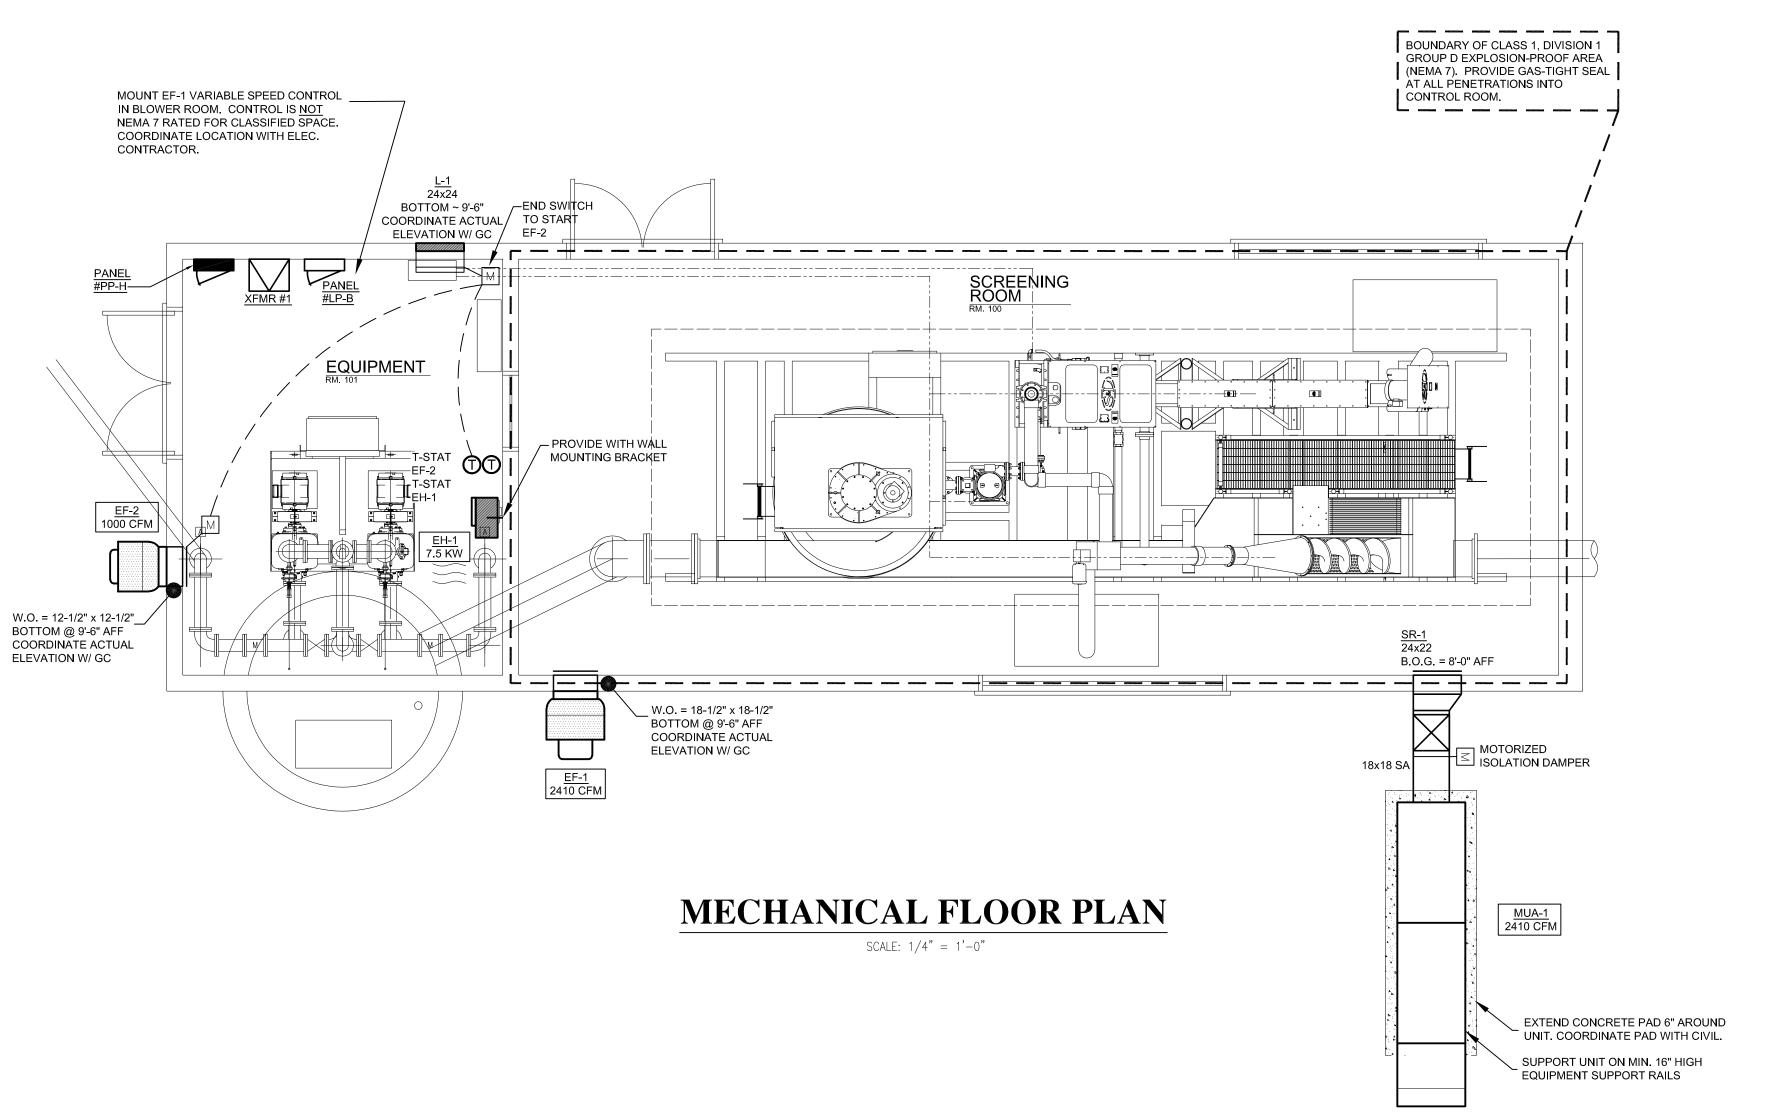 Designed By:
 JAV

 Drawn By:
 JAV

 Checked By:
 JAV

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 1/8" = 1'-0"

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Location: PART OF SECTIONS 21 & 28, T 22 N, R 16 W,

MANISTEE TOWNSHIP


MANISTEE COUNTY

MICHIGAN

Project Number: 2021096001.00

M1

	MAKE-UP AIR UNIT SCHEDULE																		
TAG	DESCRIPTION	MANUFACTURER AND MODEL	AIRFLOW (CFM)	E.S.P (IN. W.G.)	HP	INPUT (KW)	OUTPUT (KW)		HEATII	NG EAT (°F)	LAT (°F)	GAS PRESS.	WEIGHT	VOLTAGE	TRICAL I	DATA MCA	CONTROLS	OPTIONS / ACCESSOI	RIES
MAU-1	100% OUTDOOR AIR, HORIZONTAL ELECTRIC MAKE-UP AIR UNIT	GREENHECK MSX-P114-H12	2410	0.25"	1	60		ELEC.		0°F	79°F	_	984 LB	460/60/3	1	1	INTERLOCK WITH EF-1 OPERATION TO RUN CONTINUOUS. UNIT SHALL BE ABLE TO MAINTAIN DISCHARGE AIR TEMPERATURE SET POINT	WEATHERHOOD W/ BIRDSCREEN & FILTER SECTION W/ 2" ALUMINUM FILTERS 5. SING     HORIZONTAL DISCHARGE     EPOXY COAT - EXTERIOR	ZESTAT LE POINT ELECTRICAL CONNECTION

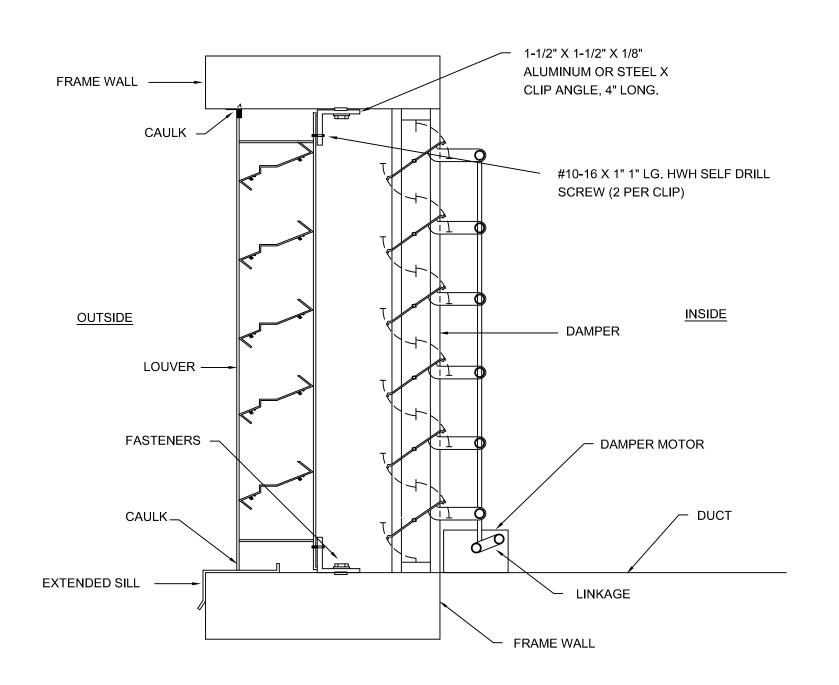

FRESH AIR LOUVER & DAMPER DETAIL NO SCALE

# EXHAUST FAN SCHEDULE

T4.0	MANUFACTURER	DRIVE	LOCATION / SERVICE	AIRFLOW	E.S.P.	SOUND LEVEL		ELE	CTRICAL			CONTROL DATA	NOTES (PEMARKS
TAG	& MODEL NO.	TYPE	LOCATION / SERVICE	(CFM)	(IN W.G.)	(SONES)	VOLTAGE	HP	ENCL	RPM	FLA	CONTROL DATA	NOTES/REMARKS
EF-1	GREENHECK CUE-160-VG	DIRECT	SCREENING ROOM 100 RELIEF / EXHAUST FAN	2410	0.24	11.2	115V   1ф   60Hz	1/2	EXP	943	6.6	CONTINUOUS - OPERATES ALONG W/ MAU-1 1	23
EF-2	GREENHECK CUE-095-VG	DIRECT	EQUIPMENT ROOM 101 EXHAUST FAN	1000	0.2	10.2	115V   1ф   60Hz	1/6	ODP	1677	2.8	REVERSE ACTING LINE VOLTAGE THERMOSTAT; SPEED CONTROL	3

OPTIONS / ACCESSORIES:

(1) VARIABLE SPEED CONTROL (SEE DRAWING NOTES)

"EXPLOSION PROOF" FAN, SPARK C CONSTRUCTION, 16 GA. GALVANIZED STEEL WALL BRACKET, LOW LEAKAGE MOTORIZED DAMPER (VCD-23, COATED), HI-PRO POLY COAT, ALUMINUM RUB RING, DIV. 1 WIRING, ALUMINUM BLADES (EPOXY COATING)

WALL BRAKET FOR WALL MOUNT CONFIGURATION, LOW LEAKAGE BACKDRAFT DAMPER (VCD-23, COATED), FAN & ACCESSORIES BASIC GRAY CORROSION RESISTANT COATING

# ELECTRIC HEATER SCHEDULE

TAG	LOCATION	MANUFACTURER	AIRFLOW	U	NIT SIZE [I	N]	ELECTRI	CAL		CONTROL DATA	ACCESSORIES/NOTES
1	LOCATION	& MODEL NO.	[CFM]	W	L	Н	VOLTAGE/PHASE	WATTS	F.L.A	CONTROL DATA	ACCESSORIES/NOTES
EH-1	HEADWORKS: RM 103	MARKEL P3PUH07	575	20	18.75	13	480V   3Ф   60Hz	7500	9.1	2	3 4 5

BASED ON MARKEL; REDD-I, RAYWALL, BERKO, Q-MARK, MARLEY ARE APPROVED EQUALS.

① - CONTROLS & ACCESSORIES RATED FOR HAZARDOUS LOCATION ② - WALL MOUNT T-STAT ③ - UNIT MOUNTED DISCONNECT ④ - SUMMER FAN SWITCH ⑤ - HEAT PURGE FAN DELAY

				V	<b>VAL</b>	LL	OU	VER	SCHEDU	JLE	
L-1 INTERLOCKED W/ EF-2 & ESD-603 1000 24 24 6 0.06 1.64 EXTRUDED MOTORIZED BACKDRAFT DAMPER; HI-PRO POLY CO.	TAG	SERVICE	MODEL ①	CFM			20.00	- Value Della Cons		MATERIAL	REMARKS
	L-1		ESD-603	1000			660		Security of the second		OPTIONS: 3/4" BIRD SCREEN; LOW-LEAKAGE (VCD-23) MOTORIZED BACKDRAFT DAMPER; HI-PRO POLY COATING COLOR BY ARCHITECT

1) BASED ON GREENHECK STATIONARY LOUVER, DRAINABLE BLADE

DIFFUSER AND GRILLE SCHEDULE										
TAG	DESCRIPTION	MANUFACTURER AND MODEL	SIZE (INCHES)	VOLUME DAMPER (TYPE, LOCATION)	MATERIAL	COLOR AND FINISH				
SR-1	SUPPLY AIR REGISTER, HEAVY DUTY AEROBLADE STYLE, 1-1/4" SPACING DOUBLE DEFLECTION, CORROSION RESISTANT; SURFACE MOUNT FRAME	TITUS 112RL	24x12	EXTERNAL	ALUMINUM	#26 WHITE				

PLUMBING FIXTURE SCHEDULE													
DESCRIPTION	MANUFACTURER /	MODEL					TRIM	REMARKS					
	MODEL		CW	HW	WASTE	VENT							
10' TRENCH DRAIN WITH END DISCHARGE	ZURN	Z886-GFG-HDG		-	4"	-	6" GALVANIZED CLASS F GRATE AND FRAME						
HOSE BIBB	WOODFORD	Y24	3/4"	-	-	-	VACUUM BREAKER, POLY HANDLE	MAINTAIN CLEARANCE TO NEARBY WALL FOR OPERABILITY					
HOSE BIBB REMOVABLE HANDLE	WOODFORD	65	3/4"	-		-		FURNISH TEE TO OWNER					
PZ-1 REDUCED PRESSURE ZONE PRINCIPLE ASSEMBLY ZURN / WILKINS 375XL 1" FACTORY LEAD FREE BRONZE "Y" STRAINER & AIR GAP													
	10' TRENCH DRAIN WITH END DISCHARGE  HOSE BIBB  HOSE BIBB REMOVABLE HANDLE  REDUCED PRESSURE ZONE PRINCIPLE	MODEL  10' TRENCH DRAIN WITH END DISCHARGE ZURN  HOSE BIBB WOODFORD  HOSE BIBB REMOVABLE HANDLE WOODFORD  REDUCED PRESSURE ZONE PRINCIPLE ZURN / WILKINS	DESCRIPTION  MANUFACTURER / MODEL  10' TRENCH DRAIN WITH END DISCHARGE  ZURN  Z886-GFG-HDG  HOSE BIBB  WOODFORD  Y24  HOSE BIBB REMOVABLE HANDLE  REDUCED PRESSURE ZONE PRINCIPLE  ZURN / WILKINS  375XI	DESCRIPTION         MANUFACTURER / MODEL         MODEL           10' TRENCH DRAIN WITH END DISCHARGE         ZURN         Z886-GFG-HDG         -           HOSE BIBB         WOODFORD         Y24         3/4"           HOSE BIBB REMOVABLE HANDLE         WOODFORD         65         3/4"           REDUCED PRESSURE ZONE PRINCIPLE         ZURN / WILKINS         375XI         1"	DESCRIPTION         MANUFACTURER / MODEL         MODEL         ROUGH (INC           10' TRENCH DRAIN WITH END DISCHARGE         ZURN         Z886-GFG-HDG         -         -           HOSE BIBB         WOODFORD         Y24         3/4"         -           HOSE BIBB REMOVABLE HANDLE         WOODFORD         65         3/4"         -           REDUCED PRESSURE ZONE PRINCIPLE         ZURN / WILKINS         375XI         1"         -	DESCRIPTION	DESCRIPTION	DESCRIPTION  MANUFACTURER / MODEL  ROUGH-IN SIZE (INCHES)  TRIM  TRIM  10' TRENCH DRAIN WITH END DISCHARGE  ZURN  Z886-GFG-HDG  4" - 6" GALVANIZED CLASS F GRATE AND FRAME  HOSE BIBB  WOODFORD  Y24  3/4" VACUUM BREAKER, POLY HANDLE  HOSE BIBB REMOVABLE HANDLE  WOODFORD  65  3/4" VACUUM BREAKER REMOVABLE TEE HANDLE  REDUCED PRESSURE ZONE PRINCIPLE  ZURN / WILKINS  375XI  1" FACTORY LEAD FREE BRONZE "Y" STRAINER & AIR GAP					



Traverse City, Michigan 231-946-9191 phone info@goslingczubak.com www.goslingczubak.com

**CIVIL ENGINEERING** SURVEYING **ENVIRONMENTAL SERVICES** GEOTECHNICAL CONSTRUCTION SERVICES DRILLING LANDSCAPE ARCHITECTURE



			WDH	By
			ISSUED FOR BIDS	Revision
			10-29-2024	Date
			1	No.

PROCESS ELECTRICAL
HEADWORKS ADDITION
LITTLE RIVER BAND OF OTTAWA INDIANS

Date Issued: Date Surveyed: Designed By: Drawn By: Checked By:


Original sheet size is 22x34

2-1-2023 8-10-2021 JAV

Location:
PART OF SECTIONS 21 & 28,
T 22 N, R 16 W, MANISTEE TOWNSHIP
MANISTEE COUNTY
MICHIGAN

2021096001.00

**M2** 

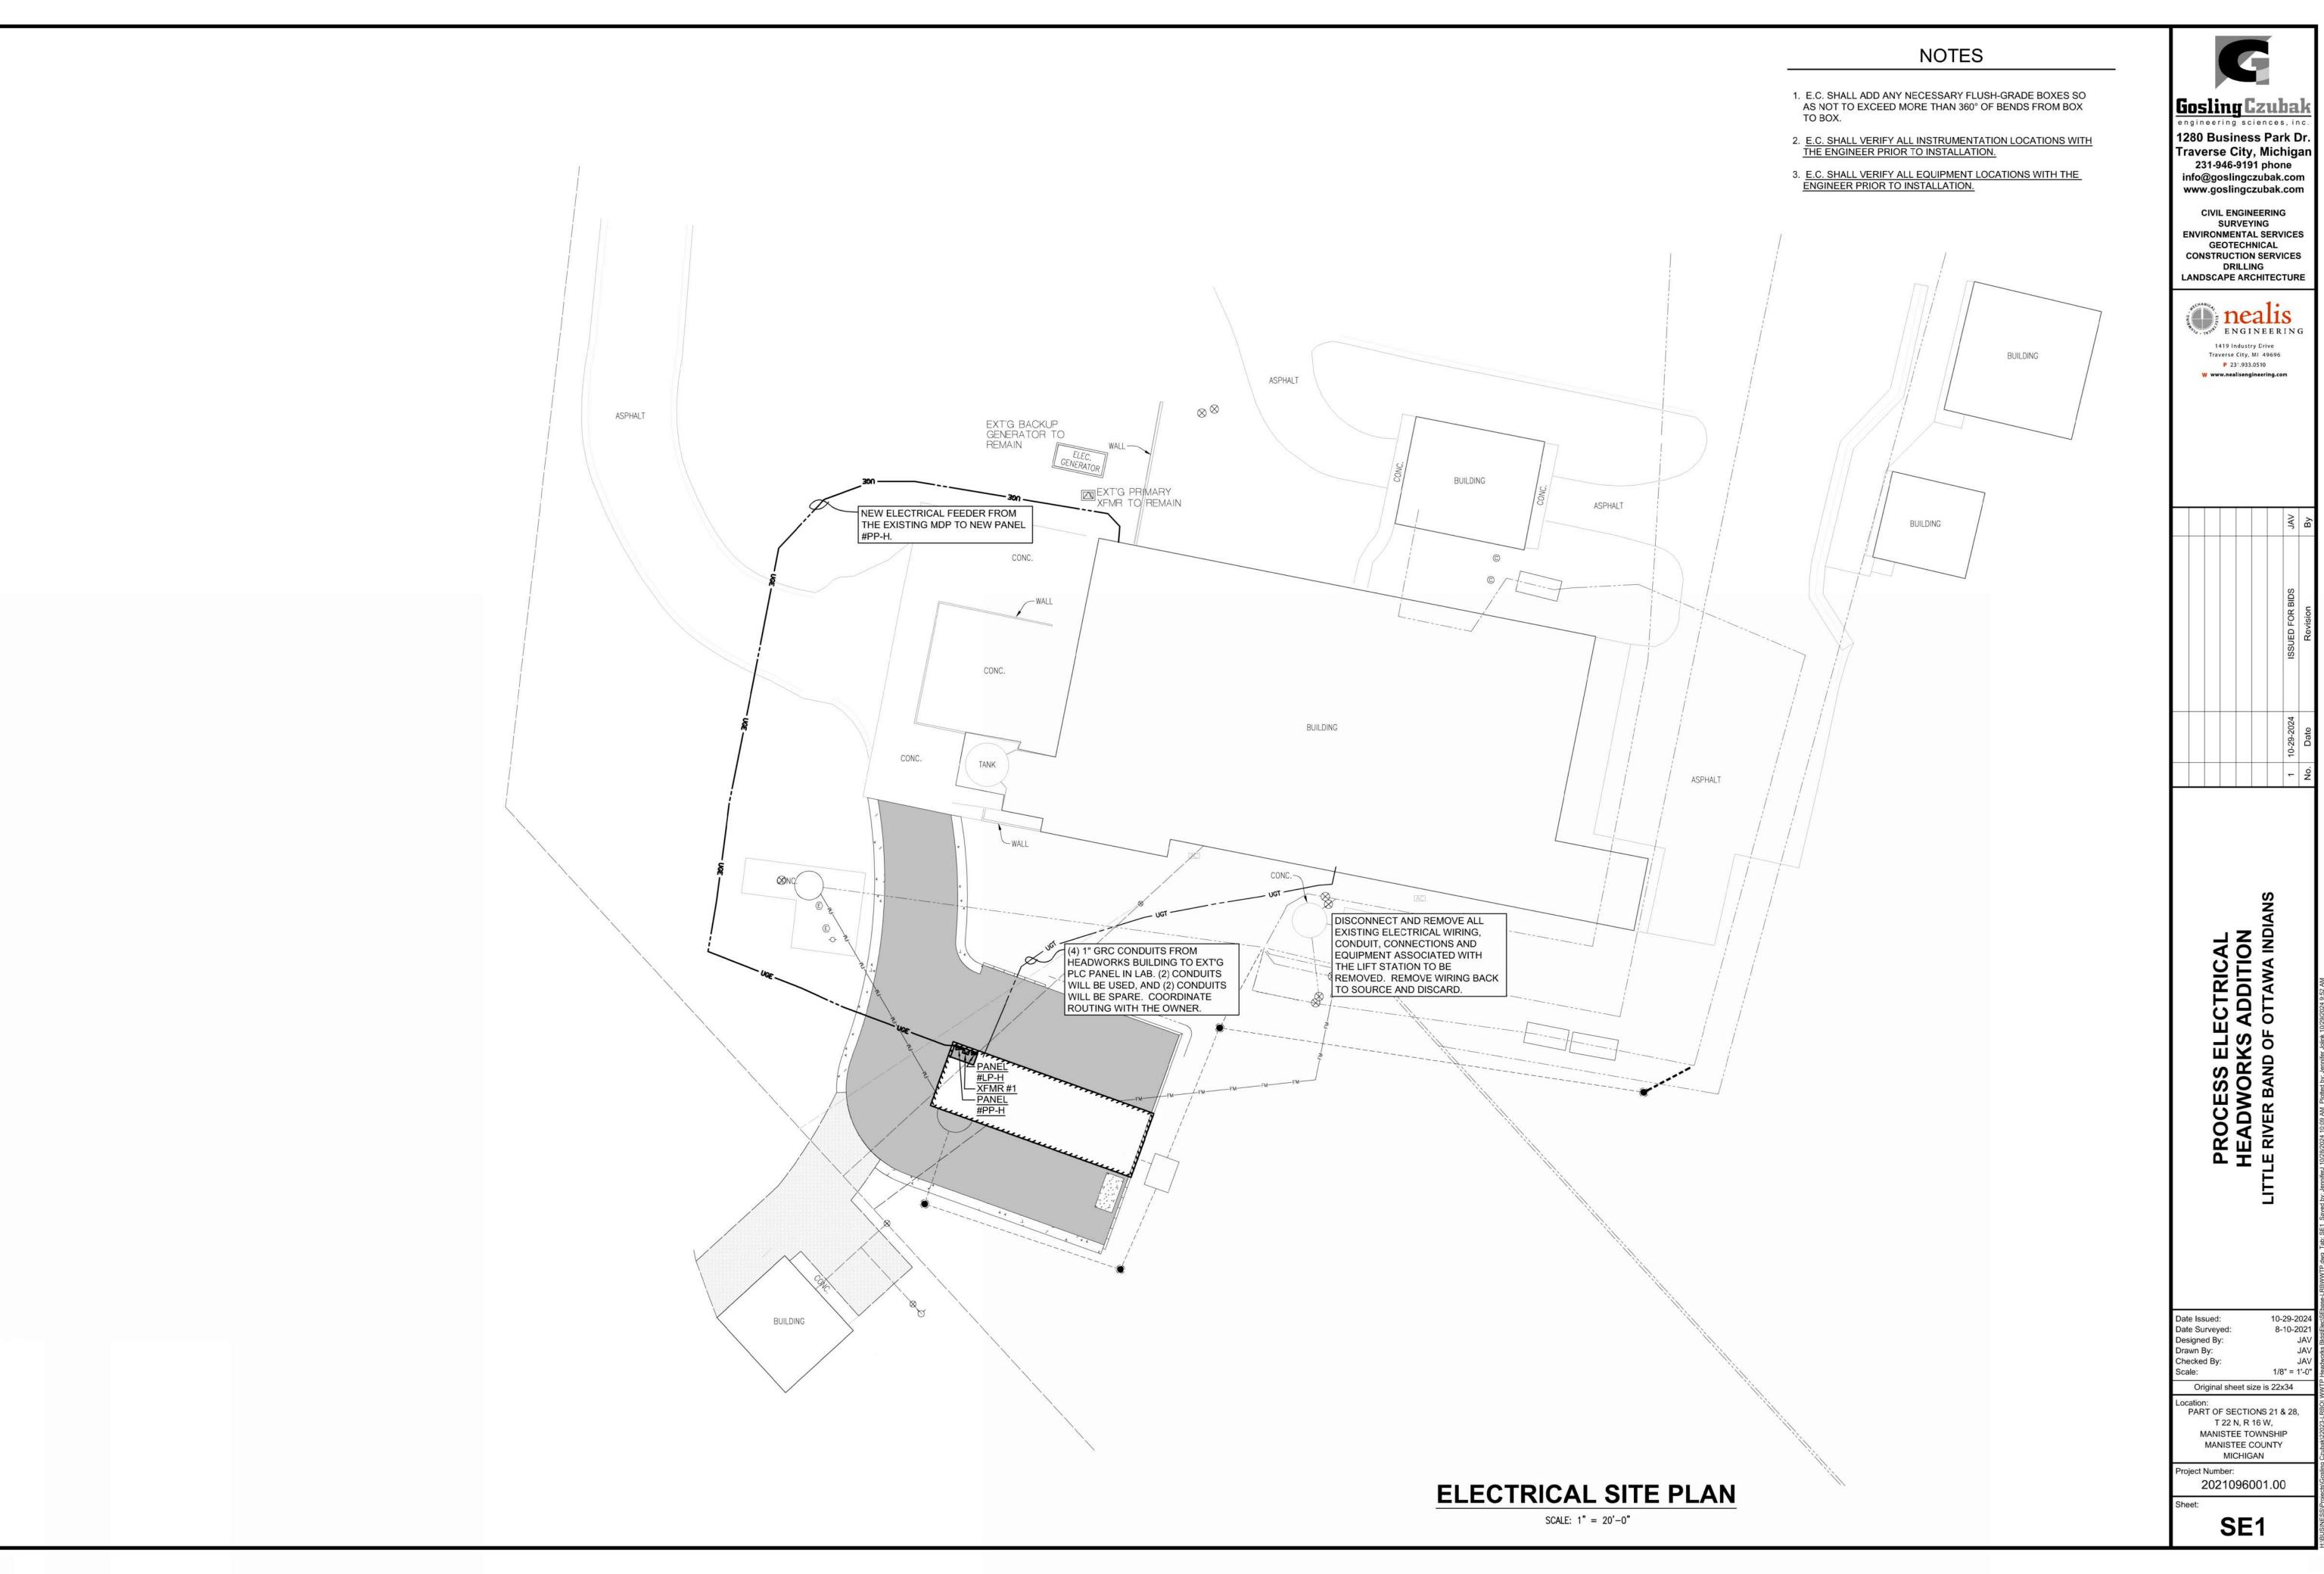

Gosling Czubak

1280 Business Park Dr. Traverse City, Michigan 231-946-9191 phone

CIVIL ENGINEERING SURVEYING **ENVIRONMENTAL SERVICES** GEOTECHNICAL CONSTRUCTION SERVICES DRILLING



		_	7	ш	ı
			ISSUED FOR BIDS	Revision	
			10-29-2024	Date	
			_	.0	

PROCESS ELECTRICAL
HEADWORKS ADDITION
LE RIVER BAND OF OTTAWA INDIANS

1/8" = 1'-0" Original sheet size is 22x34

10-29-2024 8-10-2021

T 22 N, R 16 W, MANISTEE TOWNSHIP MANISTEE COUNTY

MICHIGAN

2021096001.00

	ELECTRICAL SY	MBOL LEGEND
SYMBOL	DESCRIPTION	NOTES
S	SINGLE POLE SWITCH, (LEVITON #CSBI-20-W)	MOUNT @ 44" A.F.F. TO BOTTOM OF BOX, UNLESS OTHERWISE NOTED
S <sub>3</sub>	THREE-WAY SWITCH, (LEVITON #CSB3-20-W)	MOUNT @ 44" A.F.F. TO BOTTOM OF BOX, UNLESS OTHERWISE NOTED
$S_4$	FOUR-WAY SWITCH (LEVITON #CSB4-20-W)	MOUNT @ 44" A.F.F. TO BOTTOM OF BOX, UNLESS OTHERWISE NOTED
$\Sigma^{x}$	WALL MOUNTED FIXTURE, TYPE X	SEE LIGHTING FIXTURE SCHEDULE FOR TYPES
	ROUND FIXTURE, TYPE X	SEE LIGHTING FIXTURE SCHEDULE FOR TYPES
X	2'x4' FIXTURE, TYPE X	SEE LIGHTING FIXTURE SCHEDULE FOR TYPES
X	1'x4' FIXTURE, TYPE X	SEE LIGHTING FIXTURE SCHEDULE FOR TYPES
$\triangle^X$	WALL MOUNTED FIXTURE, TYPE X	SEE LIGHTING FIXTURE SCHEDULE FOR TYPES
$\bigotimes X$	EXIT SIGN, TYPE X	SEE LIGHTING FIXTURE SCHEDULE FOR TYPES
(PC)	PHOTOCELL	INTERMATIC #K4321
$\bigoplus_{\mathbb{W}_{P}}$	DUPLEX OUTLET - 20 AMP (LEVITON #BR20-W)	MOUNT @ 16" A.F.F. TO BOTTOM OF BOX, UNLESS OTHERWISE NOTED
Ö	DUPLEX OUTLET - WEATHER PROOF "IN-USE" COVER	MOUNT @ 24" A.F.F. TO BOTTOM OF BOX, UNLESS OTHERWISE NOTED
Ö	DUPLEX OUTLET - GROUND FAULT (LEVITON #8899-W)	MOUNT @ 16" A.F.F. TO BOTTOM OF BOX, UNLESS OTHERWISE NOTED
	DUPLEX OUTLET - DEDICATED CIRCUIT	MOUNT @ 16" A.F.F. TO BOTTOM OF BOX, UNLESS OTHERWISE NOTED
$\bigoplus$	208V, 4 WIRE OUTLET, AS SPECIFIED	MOUNT @ 16" A.F.F. TO BOTTOM OF BOX, UNLESS OTHERWISE NOTED
	SINGLE-PHASE SPECIAL PURPOSE OUTLET, AS NOTED	REFER TO SHOP DRAWINGS FOR CONNECTION REQUIREMENTS
	THREE-PHASE SPECIAL PURPOSE OUTLET, AS NOTED	REFER TO SHOP DRAWINGS FOR CONNECTION REQUIREMENTS
	WIREMOLD OR PLUG-IN STRIP, AS SPECIFIED	REFER TO SPECIFICATIONS AND DRAWINGS
J	JUNCTION BOX WITH BLANK COVER, AS SPECIFIED	
	SINGLE-PHASE MOTOR, AS SPECIFIED	
	THREE-PHASE MOTOR, AS SPECIFIED	
	SINGLE-PHASE FUSED OR NON-FUSED DISCONNECT	

SQUARE D #CLASS 2510 FGJ5P (SINGLE POLE)

REFER TO SPECIFICATIONS AND ONE-LINE DIAGRAM.

REFER TO SPECIFICATIONS AND ONE-LINE DIAGRAM.

SINGLE-PHASE MANUAL STARTER OR COMB. DISC./STARTER

THREE-PHASE MANUAL STARTER OR COMB. DISC./STARTER

THREE-PHASE FUSED OR NON-FUSED DISCONNECT

MOTOR TOGGLE SWITCH WITH THERMAL OVERLOAD

AND LOCKOUT

THERMOSTAT

EF

EGC

**EXHAUST FAN** 

**EQUIPMENT GROUNDING** 

CONDUCTOR

KVA


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DISTRIBUTION POWER PANELS

LIGHTING/BRANCH CIRCUIT PANELS

LIGHTING FIXTURE SCHEDULE									
TAG	DESCRIPTION	VOLTS	LAMPS	CATALOG NO.	REMARKS				
А	EXPLOSION PROOF CLASS I DIV. 1&2 / CLASS II DIV. 1&2 / CLASS III, LINEAR LED	120	2 LED LAMPS 64W, 7160 LUMENS, 5000K	LDPI #LE551-L4-V1-5-D-E-PB-P-WG OR PRE-APPROVED EQUAL	_				
В	4' LED SURFACE MT. WET LOCATION	120	LED, 30W, 4000 LUMENS, 4000K 85+ CRI	FAIL-SAFE #4VRVT2-LD5-4-DR100-UNV-L840-CD1- WL-SSL OR PRE-APPROVED EQUAL	-				
С	LED WALL PACK WET LOCATION	120	LED, 26W, 2710 LUMENS, 4000K 70+ CRI	LUMARK #XTOR3B-W OR PRE-APPROVED EQUAL	-				

## **ELECTRICAL IDENTIFICATION**

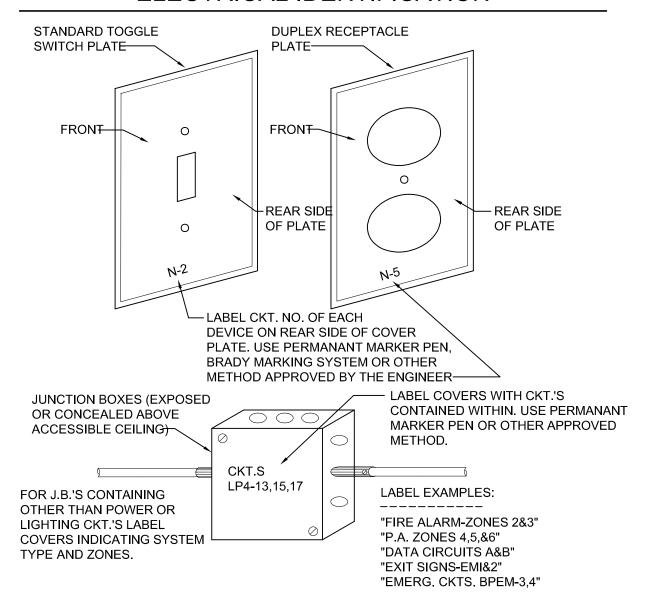

BASED ON A MAXIMUM OF 3.6-VOLT DROP (3%) ON 120V CIRCUITS.
WIRES FOR RUNS OVER 100'-0" SHALL BE DETERMINED ON THIS
A MAXIMUM OF A 3% DROP ALLOWED.

BRANCH CIRCUIT AMPS		LENG	TH OF RUN	I - FROM PA	ANEL TO FI	RST CONN	ECTION - F	EET	
AMPS	50'	60'	70'	80'	90'	100'	110'	120'	130'
15	#12	#12	#12	#10	#10	#10	#10	#10	#8
20	#12	#10	#10	#10	#10	#8	#8	#8	#8
30	#10	#10	#8	#8	#8	#6	#6	#6	#6
			-	•	•	•	•	•	•

#### PANEL 1, CIRCUIT 21 ELECTRICAL METALLIC TUBING MC MECHANICAL CONTRACTOR RGS RIGID GALVANIZED STEEL 1-21 **ENERGY RECOVERY** AMPERES MAIN CIRCUIT BREAKER TAMPER RESISTANT VENTILATOR RANSIENT VOLTAGE SURGE MAIN DISTRIBUTION PANEL **EXISTING TO BE RELOCATED** TVSS AC ABOVE COUNTER SUPPRESSION AFF ABOVE FINISH FLOOR ETR EXISTING TO REMAIN MLO UGRD MAIN LUG ONLY UNDERGROUND **ELECTRIC WATER** UNLESS OTHERWISE NOTED AFG ABOVE FINISH GRADE EWC NIGHT LIGHT UON NL COOLER **ELECTRIC WATER** BC **BELOW COUNTER** NTS NOT TO SCALE VOLT OWNER FURNISHED, С CONDUIT EXP **EXPLOSION PROOF** VFD VARIABLE FREQUENCY DRIVE CONTRACTOR INSTALLED C/B, CB CIRCUIT BREAKER G GROUND PUMP VIF VERIFY IN FIELD **GROUNDING ELECTRODE** DWG PNL DRAWING PANEL WIRE CONDUCTOR **GROUND FAULT** EXISTING TO REMAIN PS PRIMARY SWITCH WG WIREGUARD Ε CIRCUIT INTERRUPTER WP EC ELECTRICAL CONTRACTOR KCMIL THOUSAND CIRCULAR MILS PRIMARY TRANSFORMER WEATHERPROOF

PVC

POLYVINYL CHLORIDE

QUADRIPLEX (DOUBLE

DUPLEX) RECEPTACLE

XFMR

TRANSFORMER

KILOVOLT-AMPERES

KILOWATTS

**ABBREVIATIONS** 



## **GENERAL NOTES**

- WORK SHALL COMPLY WITH THE LATEST EDITION OF N.E.C., LOCAL AND STATE CODES, ORDINANCES, AND REGULATIONS, INCLUDING THE OCCUPATIONAL SAFETY AND HEALTH ACT (OSHA).
- 2. THE ELECTRICAL CONTRACTOR SHALL OBTAIN ALL PERMITS, PAY ALL FEES, AND ARRANGE FOR ALL INSPECTIONS FOR HIS WORK AT THE COMPLETION OF ELECTRICAL WORK, THE ELECTRICAL CONTRACTOR SHALL FURNISH THE OWNER WITH ALL CERTIFICATES OF FINAL INSPECTION AND APPROVALS. UTILITY COSTS ASSICIATED WITH BRINGING POWER TO THE SITE SHALL BE PAID FOR BY THE OWNER.
- 3. COORDINATE ALL NEW ELECTRICAL UNDERGROUND WORK WITH EXISTING AND NEW UTILITIES BEFORE INSTALLATION. SEVENTY-TWO HOURS BEFORE ANY EXCAVATING WORK IS DONE, RELATIVE TO ELECTRICAL WORK, CONTACT "MISS DIG" (TOLL FREE), AT (800)482-7171.
- 4. ALL ELECTRICAL MATERIALS SHALL BE NEW AND BEAR THE "UL" LABEL OR LISTING.
- 5. ALL BRANCH CIRCUIT WIRE SHALL BE COPPER, MINIMUM SIZE #12.
  A.W.G., INSTALL IN CONDUIT, MINIMUM SIZE 1/2", AND SHALL BE
  TYPE "THhN", "THWN" OR "THWN-2" UNLESS OTHERWISE NOTED ON PLANS.
- 6. ALL CONDUIT BELOW GRADE SHALL BEGALVANIZED RIGID CONDUIT. ALL OTHER CONDUIT SHALL BE EMT OR SCH. 40 PVC AS NOTED ON THE PLANS, MINIMUM 1/2" SIZE. GALVANIZED RIGID CONDUIT SHALL BE USED IN ALL CLASS 1, DIV. 1 & 2 LOCATIONS PER N.E.C. ART. 500, 501, & 502.
- 7. THE ELECTRICAL CONTRACTOR SHALL VISIT THE JOB SITE BEFORE HE SUBMITS HIS BID TO FAMILIARIZE HIMSELF WITH ACTUAL JOB CONDITIONS AND TO CHECK FOR ANY INTERFERENCE BETWEEN HIS WORK AND THAT OF OTHER TRADES, AND/OR ANY APPARENT VIOLATIONS OF LOCAL OR STATE CODES, LAWS, ORDINANCES, AND REGULATIONS.
- 8. ALL EQUIPMENT SHALL BE GROUNDED IN ACCORDANCE WITH THE N.E.C. AND ALL LOCAL CODES.
- 9. ALL DISCONNECT SWITCHES SHALL BE 250V., OR 600V HEAVY DUTY TYPE; NEMA 1, FOR INDOOR USE, AND NEMA 3R FOR OUTDOOR USE. G.E., CUTLER-HAMMER, OR SQUARE D.
- 10. THE ELECTRICAL CONTRACTOR SHALL GUARANTEE ALL WORK INSTALLED UNDER HIS CONTRACT TO BE FREE FROM DEFECTIVE WORKMANSHIP AND MATERIALS FOR A PERIOD OF ONE YEAR AFTER THE ACCEPTANCE OF THE BUILDING BY THE OWNER, AND SHOULD DEFECTS OCCUR WITHIN THIS PERIOD, REPAIR AND /OR REPLACE DEFECTIVE ITEMS, AT NO EXPENSE TO THE OWNER.

- 11. ANY CUTTING AND/OR PATCHING, THAT MAY BE REQUIRED FOR THE INSTALLATION OF THE ELECTRICAL SYSTEM, SHALL BE DONE AND/OR REPAIRED BY THE ELECTRICAL CONTRACTOR. NO CUTTING OF THE BUILDING STRUCTURAL SYSTEM SHALL BE DONE WITHOUT THE WRITTEN CONSENT OF THE ENGINEER BEING PREVIOUSLY OBTAINED.
- 12. ALL WORK WITHIN CLASS I, DIV. 1 & 2 SHALL COMPLY WITH ARTICLES 500, 501, 502, 511, 511, 514 & 515.OF THE N.E.C.
- 13. ELECTRICAL CONTRACTOR SHALL VERIFY AVAILABLE FAULT CURRENT WITH LOCAL UTILITY COMPANY. FAULT CURRENT WAS NOT AVAILABLE AT TIME OF DESIGN. FOR PURPOSES OF BIDDING ASSUME ALL SWITCH GEAR TO BE 42,000 A.I.C. RATED. ALL SWITCH GEAR SHALL BE U.L.S.E. LABELED FOR INTENDED USE.
- 14. THE ELECTRICAL CONTRACTOR SHALL VERIFY IN THE FIELD THAT BRANCH CIRCUITS AND/OR FEEDERS DO NOT EXCEED THE FOLLOWING LENGTHS FOR THE GIVEN VOLTAGES, IF THEY DO, THE RESPECTIVE CIRCUITS AND/OR FEEDER CONDUCTORS AND CONDUIT SHALL BE INCREASED AS FOLLOWS:
- A. 120V BRANCH CIRCUITS AND/OR FEEDERS OVER 100' IN LENGTH SHALL BE INCREASED ONE WIRE GAUGE SIZE. CONDUIT SHALL BE INCREASED IF REQ'D.
- B. 208/240V BRANCH CIRCUITS AND OR FEEDERS OVER 200' IN LENGTH SHALL BE INCREASED ONE WIRE GAUGE SIZE. CONDUIT SHALL BE INCREASED IF REQ'D.
- 15. THE ELECTRICAL CONTRACTOR SHALL SIZE ALL OUTLET, AND JUNCTION BOXES PER THE 2023 N.E.C.
- 16. NOT USED
- 17. NO SPLICES SHALL BE PERFORMED ON LOW VOLTAGE WIRING OR MANUFACTURER SUPPLIED CABLING.
- 18. CONTRACTOR SHALL LEAVE A MINIMUM OF 10 FEET OF WIRING BEYOND TERMINATION POINT WHERE TERMINATION IS PROVIDED BY OTHERS.
- 19. NOT USED

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engineering sciences, inc.


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TRICAL LEGEND, SCHEDULES & NO HEADWORKS ADDITION
LITTLE RIVER BAND OF OTTAWA INDIANS

Date Issued:
Date Surveyed:
Designed By:
Drawn By:
Checked By:
Scale:

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ecked By: JAV ale: 1/8" = 1'-0" Original sheet size is 22x34

10-29-2024

8-10-2021

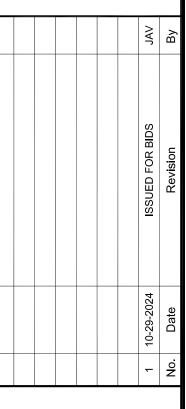Location: PART OF SECTIONS 21 & 28, T 22 N, R 16 W, MANISTEE TOWNSHIP

MANISTEE TOWNSHIP
MANISTEE COUNTY
MICHIGAN
Project Number:

2021096001.00

neet:

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CIR NO.	AMP/ POLES	DESCRIPTION	LOAD	LOAD	DESCRIPTION	AMP/ POLES	CIR NO
1					<u>CP-1</u> - <u>M-1</u> , <u>M-2</u> , <u>M-3</u> , & <u>M-4</u>		2
3	15/3	<u>EH-1</u> - 7.5 KW	7500	12589	SCREEN-1 HP; CHAMBER DRIVE-1 HP;	30/3*	4
5					PUMP-5 HP; CLASSIFER-1 HP;		6
7					<u>CP-2</u> - <u>M-5</u> & <u>M-6</u>		8
9	80/3*	<u>MUA-1</u> - 78.1 MCA	64931	19281	EFFLUENT PUMP 1 - 15 HP;	60/3	10
11					EFFLUENT PUMP 2 - 15 HP;		12
13				_	SPACE	_	14
15	25/3	TR3 - HEADWORKS - 15KVA	5601	_	SPACE	_	16
17				_	SPACE	_	18
19		SPACE	_	_	SPACE	_	20
21		SPACE	_	_	SPACE	_	22
23		SPACE	_	_	SPACE	_	24
25		SPACE		_	SPACE	_	26
27		SPACE		_	SPACE	_	28
29		SPACE	_	_	SPACE	_	30

200 AMPS M.C.B. 480/277V-3Ø-4W SQUARE D TYPE NF SURFACE

TOTAL PANEL LOAD = 109.902 W - 132.2 A

D DENOTES CIRCUIT REQUIRED TO PASS THRU LIGHTING CONTROL PANEL.

DENOTES ARC FAULT CIRCUIT INTERRUPTER (AFCI) CIRCUIT BREAKER REQUIRED.

DENOTES GROUND FAULT CIRCUIT INTERRUPTER (GFCI) CIRCUIT BREAKER REQUIRED.

) DENOTES GROUND FAULT CIRCUIT INTERRUPTER (GFCI) CIRCUIT BREAKER REQUIRED. ) DENOTES CIRCUIT BREAKER WILL REQUIRE SHUNT-TRIP OR TO BE RUN THROUGH SHUNT-TRIP CONTACTOR.

B) DENOTES BREAKER LOCK REQUIRED ON CIRCUIT BREAKER.

E) DENOTES 30mA GROUND FAULT EQUIPMENT PROTECTION (GFEP) CIRCUIT BREAKER REQUIRED.

\* DENOTES CONTRACTOR TO CONFIRM EXACT CIRCUIT BREAKER SIZE WITH EQUIPMENT SUBMITTALS.

P	ANE	L #LP-H			1.C.B. 120/208V-3Ø⊑4W SQUARE D TYPE N FH TRIM KIT, GROUND BAR KIT, COPPER		SOLID
CIR NO.	AMP/ POLES	DESCRIPTION	LOAD	LOAD	DESCRIPTION	AMP/ POLES	CIR NO.
1	20/1	LIGHTS - INTERIOR & EXTERIOR	540	759	<u>EF-1</u>	20/1	2
3	20/1	SPARE	_	422	<u>EF-2, L-1</u>	20/1	4
5	20/1	RECEPTACLES - INTERIOR	540	1100	M-7 - ACTUATED VALVE 1 & FM-2	20/1	6
7	20/1	RECEPTACLES - EXTERIOR	540	1100	<u>M-8</u> - ACTUATED VALVE 2 & <u>FM-1</u>	20/1	8
9	20/1	CP-3 - GAS MONITORING CONTROL PANEL	600	-	SPARE	20/1	10
11	20/1	SPARE	_	_	SPARE	20/1	12
13	20/1	SPARE	_	_	SPARE	20/1	14
15		SPACE	_	_	SPACE	_	16
17		SPACE	_	<b>  -</b>	SPACE	_	18

TOTAL PANEL LOAD = 5,601 W - 15.5 A

D) DENOTES CIRCUIT REQUIRED TO PASS THRU LIGHTING CONTROL PANEL.

A) DENOTES ARC FAULT CIRCUIT INTERRUPTER (AFCI) CIRCUIT BREAKER REQUIRED.

G DENOTES GROUND FAULT CIRCUIT INTERRUPTER (GFCI) CIRCUIT BREAKER REQUIRED.
S DENOTES CIRCUIT BREAKER WILL REQUIRE SHUNT-TRIP OR TO BE RUN THROUGH SHUNT-TRIP CONTACTOR.


DENOTES BREAKER LOCK REQUIRED ON CIRCUIT BREAKER.


© DENOTES 30mA GROUND FAULT EQUIPMENT PROTECTION (GFEP) CIRCUIT BREAKER REQUIRED.

# NOTES

- ALL ELECTRICAL EQUIPMENT AND WIRING METHODS SHALL MEET LATEST ENFORCEABLE EDITION OF THE N.E.C. CLASS I, DIVISION 1, GROUP C & D, HAZARDOUS LOCATIONS IN SCREENING ROOM #100.
- 2. ALL ELECTRICAL PIPING IN CLASS I, DIVISION 1, GROUP C & D SHALL BE PVC COATED RIGID CONDUIT, SURFACE MOUNTED. ALL OTHER CONDUIT SHALL BE (GRS) UNLESS NOTED OTHERWISE ON DRAWINGS. USE PVC CONDUIT STRAPS
- 3. NOT USED
- 4. NOT USED
- 5. NOT USED.
- 6. STROBE WARNING LIGHT (1) SUPPLIED BY CONTROL PANEL MANUFACTURER (CP-3). INSTALLED & WIRED BY E.C.
- 7. T.C.C. SHALL INTERLOCK MAU-1 AND EF-1 TOGETHER THROUGH RELAY/CONTACTOR. JUNCTION BOX SHALL BE NEMA #3R ENCLOSURE. BOTH MAU-1 AND EF-1 SHALL RUN TOGETHER. A ROOM THERMOSTAT SHALL CONTROL THE HEAT CYCLE ON MAU-1.
- 8. <u>E.C. SHALL VERIFY ALL INSTRUMENTATION LOCATIONS WITH THE ENGINEER PRIOR TO INSTALLATION.</u>
- 9. E.C. SHALL VERIFY ALL EQUIPMENT LOCATIONS WITH THE ENGINEER
- 10. GROUNDING ELECTRODE CONDUCTOR (G.E.C.) AND/OR EQUIPMENT GROUNDING CONDUCTORS (E.G.C.) SHALL BE REQUIRED IN ALL CONDUIT, SIZED PER TABLES 250-66 & 250-122 RESPECTIVELY.



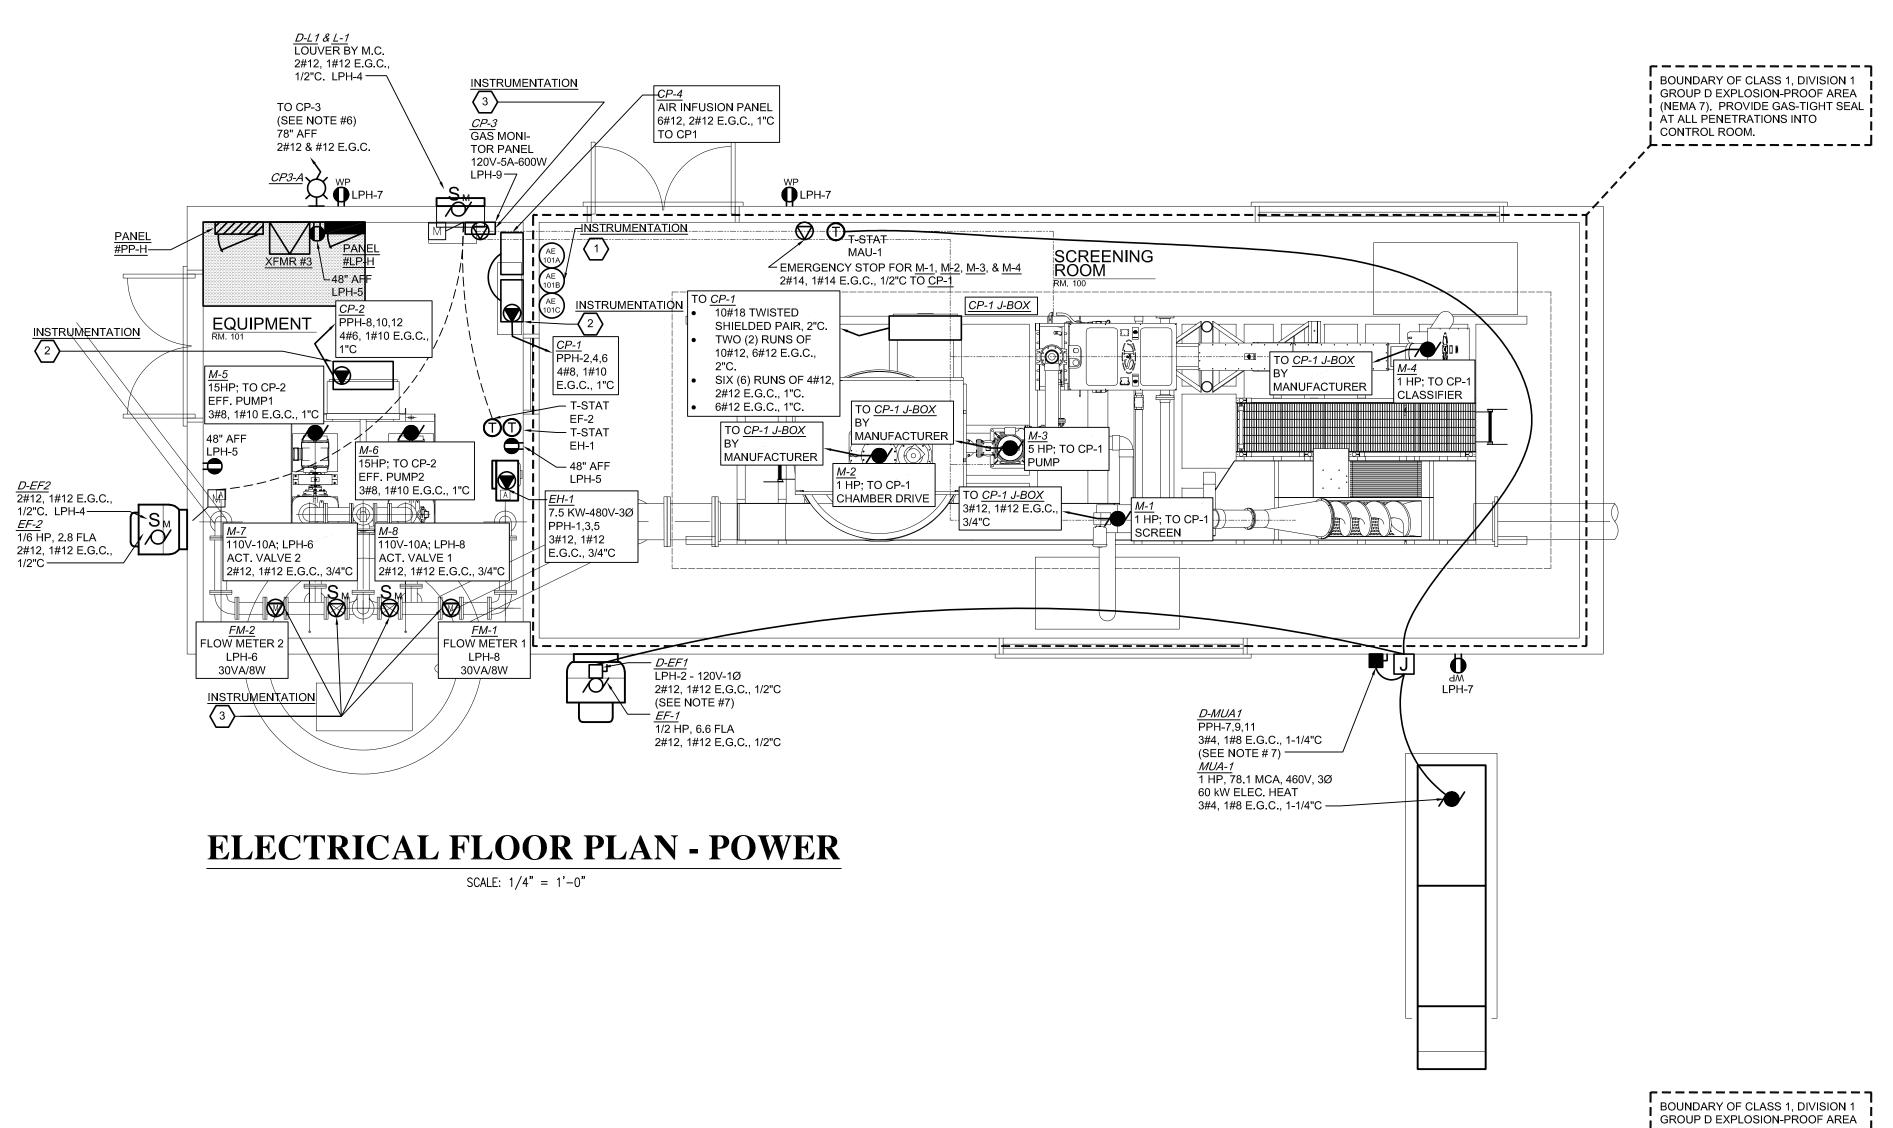

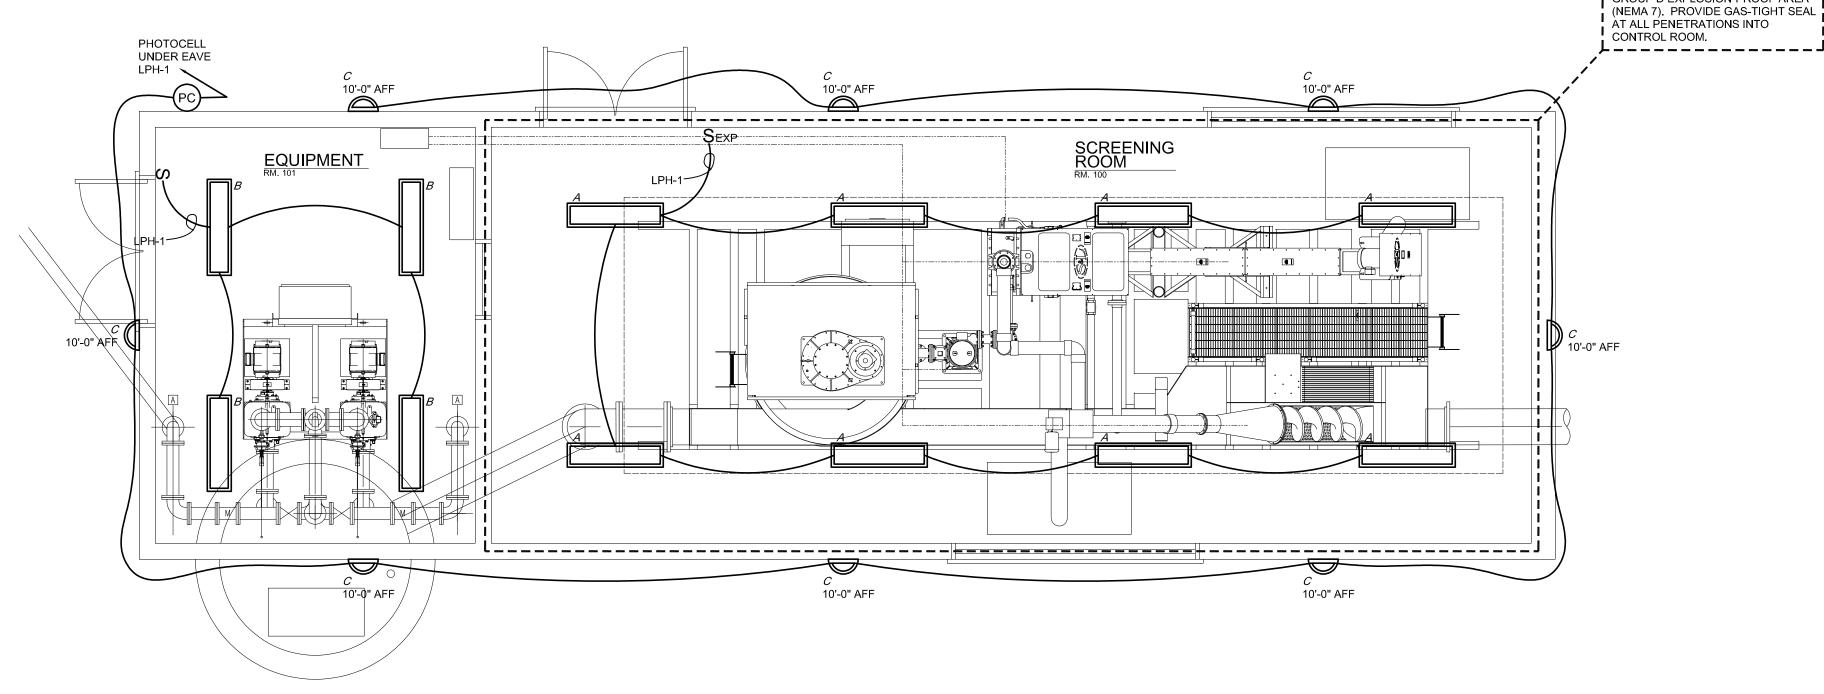

# **ELECTRICAL FLOOR PLAN - LIGHTING**

SCALE: 1/4" = 1'-0"

Environmental Services

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SS ELECTRICAL FLOOR PLAN HEADWORKS ADDITION E RIVER BAND OF OTTAWA INDIANS

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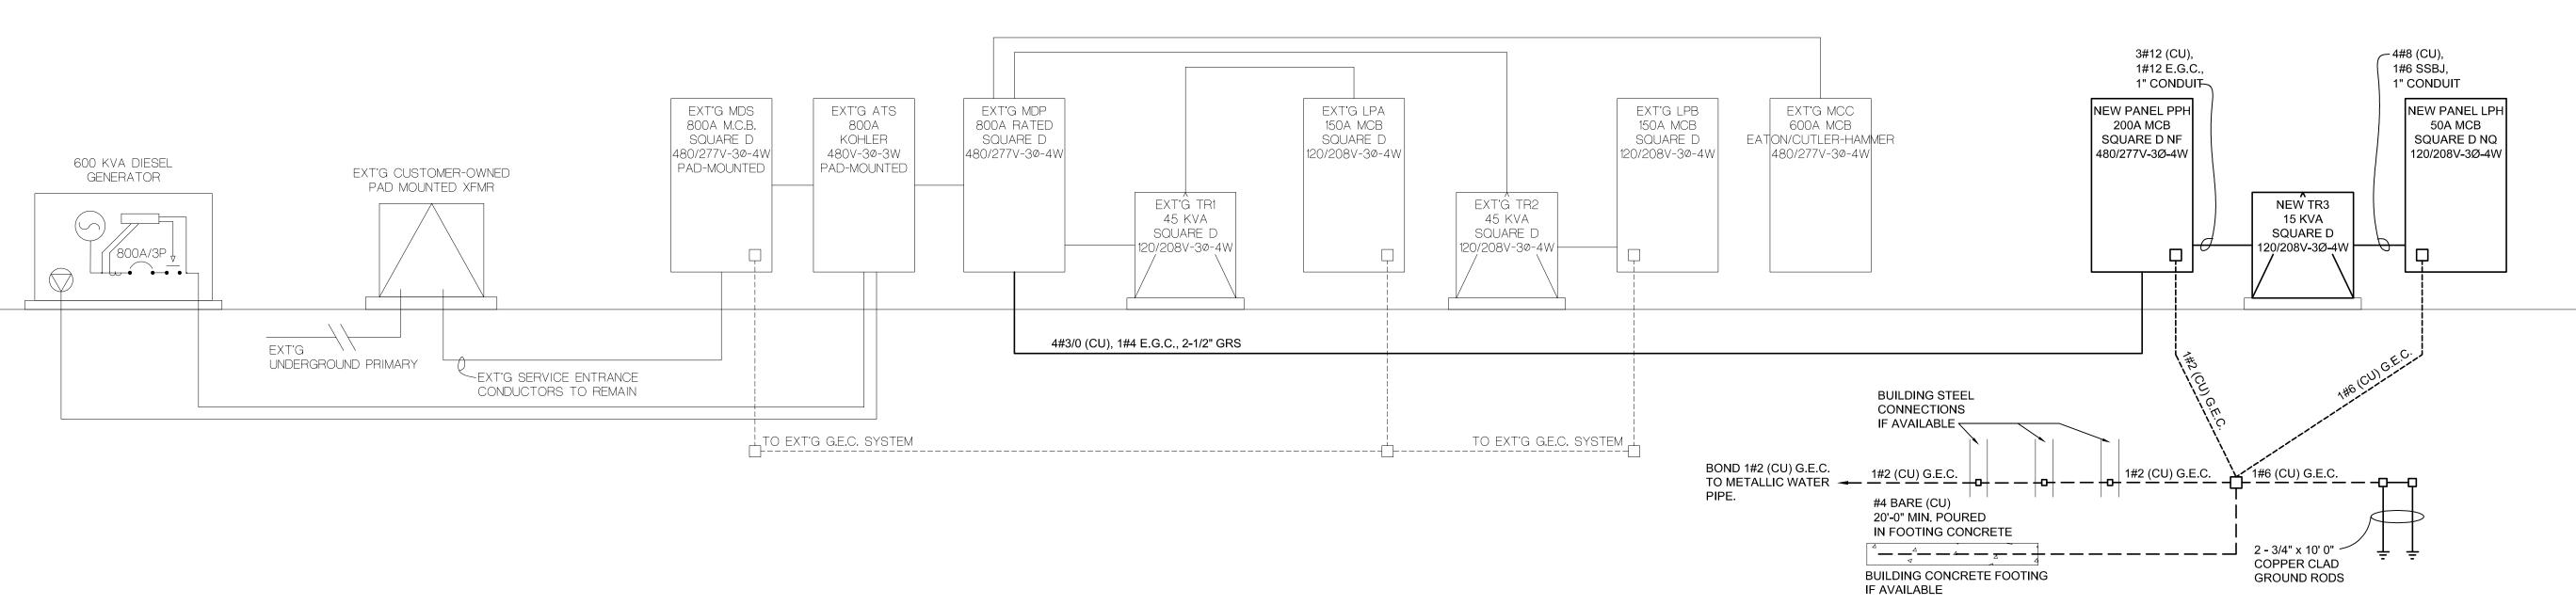
Date Issued:

Sheet:

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# ELECTRICAL RISER DIAGRAM

NO SCALE



EX	T'(	3 PANEL #MDP-1				EXT'G PANEL #MDP-1  800 AMPS M.L.O. 480/277V-30-4W SQUARE D TYPE I-LINE NEMA 1 SURFACE PANEL											
	AMP/ POLES	DESCRIPTION	LOAD	LOAD	DESCRIPTION	AMP/ POLES	CIR NO.										
1 3 5	70/3	T-2 - 45 KVA			T-1 - 45 KVA	70/3	2 4 6										
7 9 11	20/3	MAU-2			MUFFIN MONSTER	20/3	8 10 12										
13 15 17	30/3	SEPTAGE PUMP			MUFFIN MONSTER	30/3	14 16 18										
19 21 23	30/3	C-1			SLUDGE PUMP	30/3	20 22 24										
25 27 29	100/3	HYDRO TANK BUILDING			EXHAUST FANS 1, 2 & 3	20/3	26 28 30										
31 33 35	60/3	LIFT STATION			DISK FILTER	100/3	32 34 36										
37 39 41	60/3	LIME SILO FEED		109,902	NEW PANEL #PP-H (HEADWORKS BLDG)	200/3*	38 40 42										
43 -		SPACE			SPACE		44										
45					SPACE		46										
47	40/3	UNKNOWN LOAD			SPACE		48										
49					SPACE		50										
51		SPACE			SPACE		52										
53		SPACE			SPACE		54										
55		SPACE			SPACE		56										
57		SPACE			SPACE		58										
		SPACE			SPACE		60										
61		SPACE			SPACE		62										
63					SPACE		64										
	300/3	MCC			SPACE		66										
67					SPACE		68										
69		SPACE			SPACE		70										
• •		SPACE			SPACE		72										
70		SPACE			SPACE		74										
-		SPACE			SPACE		76										
• •		SPACE			SPACE		78										
79		SPACE			SPACE		80										

* DENOTES TO PROVIDE A NEW CIRCUIT	BREAKER,	SIZED AS NOTED,	IN AN EXISTING SPACE
EXT'G PEAK DEMAND PANEL LOAD:	105.2 KW	126.5 A	
+25% PER NEC 220.87	26.3 KW	31.6 A	

723% FER NEG 220.07	20.3 KVV	31.0 A
ADDED LOAD:	109.9 KW	132.2 A
REMOVED LOAD:	( 22.4 KW)	( 27.0 A)
TOTAL NEW LOAD:	219.0 KW	263.4 A

NO.	LOAD	VOLTS	PHASE	BREAKER/ FUSE SIZE	STARTER SIZE	FED FROM	CONDUIT & WIRE SIZE	SUPPLIED BY	INSTALLED BY	WIRED BY	CATALOG NUMBER	REMARKS
PANEL #PP-H	200A MCB	480V	3Ø	200A/3P MCB	_	xMDP	2-1/2" C, 4#3/0, 1#4 E.G.C.,	E.C.	E.C.	E.C.	SQUARE D #NF SERIES	PANEL #PP-H NEMA 1
TR3	15 kVA	480V TO 120/208V	3Ø	25A/3P 	_	PANEL #PP-H	1" C 3#12	E.C.	E.C.	E.C.	SQUARE D #EXN15T3H	TRANSFORMER #3 NEMA 1
PANEL #LP-H	1 1	120/208V	3Ø	50A/3P MCB	_	TR3	1" C, 4#8, 1#6 SSBJ & G.E.C.	E.C.	E.C.	E.C.	SQUARE D #NQ SERIES	PANEL #LP-H NEMA 1
EH-1	7.5 KW	480V	3Ø	15A/3P C.B. IN PANEL PPH	_	PANEL #PP-H	3/4" C, 3#12, 1#12 E.G.C.,	M.C.	M.C.	E.C.		ELECTRIC HEATER #1
D-MUA1	78.1MCA	480V	3Ø	100A/3P NON-FUSED	_	PANEL #PP-H	1-1/4" GRS, 3#4, 1#8 E.G.C.	E.C.	E.C.	E.C.	SQ. D #VHU363DSGL	MUA-1 DISCONNECT SWITCH NEMA #4 & 4X RATED
MUA-1	3/4 HP	480V	3Ø	80A/3P* C.B.	_	D-MUA1	1-1/4" C, 3#4, 1#8 E.G.C.	M.C.	M.C.	E.C.		MAKE-UP AIR UNIT #1
CP <b>-</b> 1	_	480V	3Ø		_	PANEL #PP-H	1" C 4#8	M.C.	M.C.	E.C.	<del></del>	SCREEN, CHAMBER DRIVE, PUMP & CLASSIFIER CONTROL PANEL
M-1	1 HP	480V	3Ø		_	CP-1 J-BOX	MANUFACTURERS CABLE TO CP-1 J-BOX	M.C.	M.C.	M.C.		SCREEN
M <b>-</b> 2	1 HP	480V	3Ø		_	CP-1 J-BOX	MANUFACTURERS CABLE TO CP-1 J-BOX	M.C.	M.C.	M.C.		CHAMBER DRIVE
M <b>-</b> 3	5 HP	480V	3Ø		_	CP-1 J-BOX	MANUFACTURERS CABLE TO CP-1 J-BOX	M.C.	M.C.	M.C.		PUMP
M-4	1 HP	480V	3Ø		_	CP-1 J-BOX	MANUFACTURERS CABLE TO CP-1 J-BOX	M.C.	M.C.	M.C.		CLASSIFIER
CP-4	_	120V	1Ø		_	CP-1	1" C, 6#12, 2#12 E.G.C.,	M.C.	M.C.	E.C.		AIR INFUSION PANEL
CP-2	_	480V	3Ø		_	PANEL #PP-H	1" C 1#6	M.C.	M.C.	E.C.		EFFLUENT PUMPS CONTROL PANEL
M-5	15 HP	480V	3Ø		_	CP-2	1" C, 3#8, 1" D. G.G.C.,	M.C.	M.C.	E.C.	<del></del>	EFFLUENT PUMP 1
M-6	15 HP	480V	3Ø		_	CP-2	1" C, 3#8, 1#10 E.G.C.,	M.C.	M.C.	E.C.		EFFLUENT PUMP 2
D-EF1	_	120V	1Ø	20A/1P FUSED	_	PANEL #LP-H	1/2" C, 2#12, 1/412 E.G.C.,	E.C.	E.C.	E.C.	SQ. D #H60XBDAA	EXHAUST FAN #1 DISCONNECT SWITCH CLASS 1, DIV. 1, GROUP C & D
EF-1	1/2 HP	120V	1Ø		_	D-EF1	1/2" C, 2#12, 1/2 E.G.C.,	M.C.	M.C.	E.C.	<del></del>	EXHAUST FAN #1
CP-3	5.0 A	120V	1Ø		_	PANEL #LP-H	1/2" C 2#12	M.C.	M.C.	E.C.		GAS MONITORING CONTROL PANEL #1
D-L1	_	120V	1Ø	20A/1P FUSED	_	PANEL #LP-H	1/2" C, 2#12,	E.C.	E.C.	E.C.	SQ. D CLASS 2510	LOUVER #2 DISCONNECT SWITCH
L-1	_	120V	1Ø	 	_	D-L1	1#12 E.G.C., 1/2" C, 2#12,	M.C.	M.C.	E.C.	#FW1P	NEMA 4 LOUVER #1
D-EF2	_	120V	1Ø	20A/1P	_	PANEL #LP-H	1#12 E.G.C., 1/2" C, 2#12,	E.C.	E.C.	E.C.	SQ. D CLASS 2510	EXHAUST FAN #2 DISCONNECT SWITCI
EF-2	1/6 HP	120V	1Ø	FUSED 	_	D-EF2	1#12 E.G.C., 1/2" C, 2#12,	M.C.	M.C.	E.C.	#FW1P	NEMA 4 EXHAUST FAN #2
D-M7	_	120V	1Ø	20A/1P	_	PANEL #LP-H	1#12 E.G.C., 1/2" C, 2#12,	E.C.	E.C.	E.C.	SQ. D CLASS 2510	ACTUATED VALVE #2 DISCONNECT SWIT
M-7	1/6 HP	120V	1Ø	FUSED 	_	D-M7	1#12 E.G.C., 1/2" C, 2#12,	M.C.	M.C.	E.C.	#FW1P	NEMA 4 ACTUATED VALVE 2
D-FM2	_	120V	1Ø	20A/1P	_	PANEL #LP-H	1#12 E.G.C., 1/2" C, 2#12,	E.C.	E.C.	E.C.	SQ. D CLASS 2510	FLOW METER #2 DISCONNECT SWITCH
FM-2	30VA/8W	120V	1Ø	FUSED 	_	D-FM2	1#12 E.G.G., 1/2" C, 2#12,	M.C.	M.C.	E.C.	#FW1P	NEMA 4 FLOW METER #2
D-M8	_	120V	1Ø	20A/1P	_	PANEL #LP-H	1#12 E.G.C., 1/2" C, 2#12,	E.C.	E.C.	E.C.	SQ. D CLASS 2510	ACTUATED VALVE #1 DISCONNECT SWIT
M-8	1/6 HP	120V	1Ø	FUSED 	_	D-M8	1#12 E.G.C., 1/2" C, 2#12,	M.C.	M.C.	E.C.	#FW1P	NEMA 4 ACTUATED VALVE 1
D-FM1		120V	1Ø	20A/1P		PANEL #LP-H	1#12 E.G.C., 1/2" C, 2#12,	E.C.	E.C.	E.C.	SQ. D CLASS 2510	FLOW METER #1 DISCONNECT SWITCH
FM-1	30VA/8W	120V	1Ø	FUSED 		D-FM1	1#12 E.G.C., 1/2" C, 2#12,	M.C.	M.C.	E.C.	#FW1P	NEMA 4 FLOW METER #1


G.C. - GENERAL CONTRACTOR M.C. - MECHANICAL CONTRACTOR

Gosling Czubak engineering sciences, inc. 1280 Business Park Dr.

Traverse City, Michigan 231-946-9191 phone info@goslingczubak.com www.goslingczubak.com **CIVIL ENGINEERING** 

SURVEYING **ENVIRONMENTAL SERVICES** GEOTECHNICAL CONSTRUCTION SERVICES DRILLING LANDSCAPE ARCHITECTURE



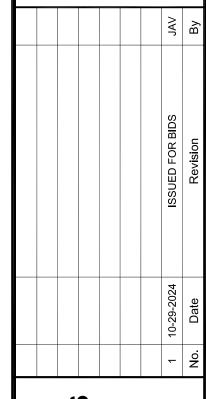

HEDUL CAL RISER DIAGRAM & PNL SCH HEADWORKS ADDITION LITTLE RIVER BAND OF OTTAWA INDIANS

Date Issued: 8-10-2021 Date Surveyed: Designed By: Drawn By: Checked By: Original sheet size is 22x34

PART OF SECTIONS 21 & 28, T 22 N, R 16 W,

MANISTEE TOWNSHIP MANISTEE COUNTY MICHIGAN

Project Number: 2021096001.00

**E2** 

E.C. - ELECTRICAL CONTRACTOR

I.C. - INSTRUMENTATION CONTRACTOR